



PHILIPPINE
PORTS
AUTHORITY

PMO- MINDORO

VARIOUS REPAINTING WORKS

PORT OF PUERTO GALERA, ORIENTAL MINDORO

PROJECT TITLE: VARIOUS REPAINTING WORKS
 PORT OF PUERTO GALERA, ORIENTAL MINDORO

PREPARED BY: EDWARD S. MALIBY
 (Draftsman II)

SUBMITTED BY: EDWARD S. MALIBY
 (Draftsman II)

CHECKED / REVIEWED BY: EDWARD S. MALIBY
 (Draftsman II)

RECOMMENDING ENGINEER: EDWARD S. MALIBY
 (Draftsman II)

APPROVED BY: EDWARD S. MALIBY
 (Draftsman II)


SHEET CONTENTS: AS SHOWN

SCALE: AS SHOWN

SHEET NO. 1 of 3


PORT LAYOUT PLAN
 PORT OF PUERTO GALERA
 ORIENTAL MINDORO

SCALE 1:500M

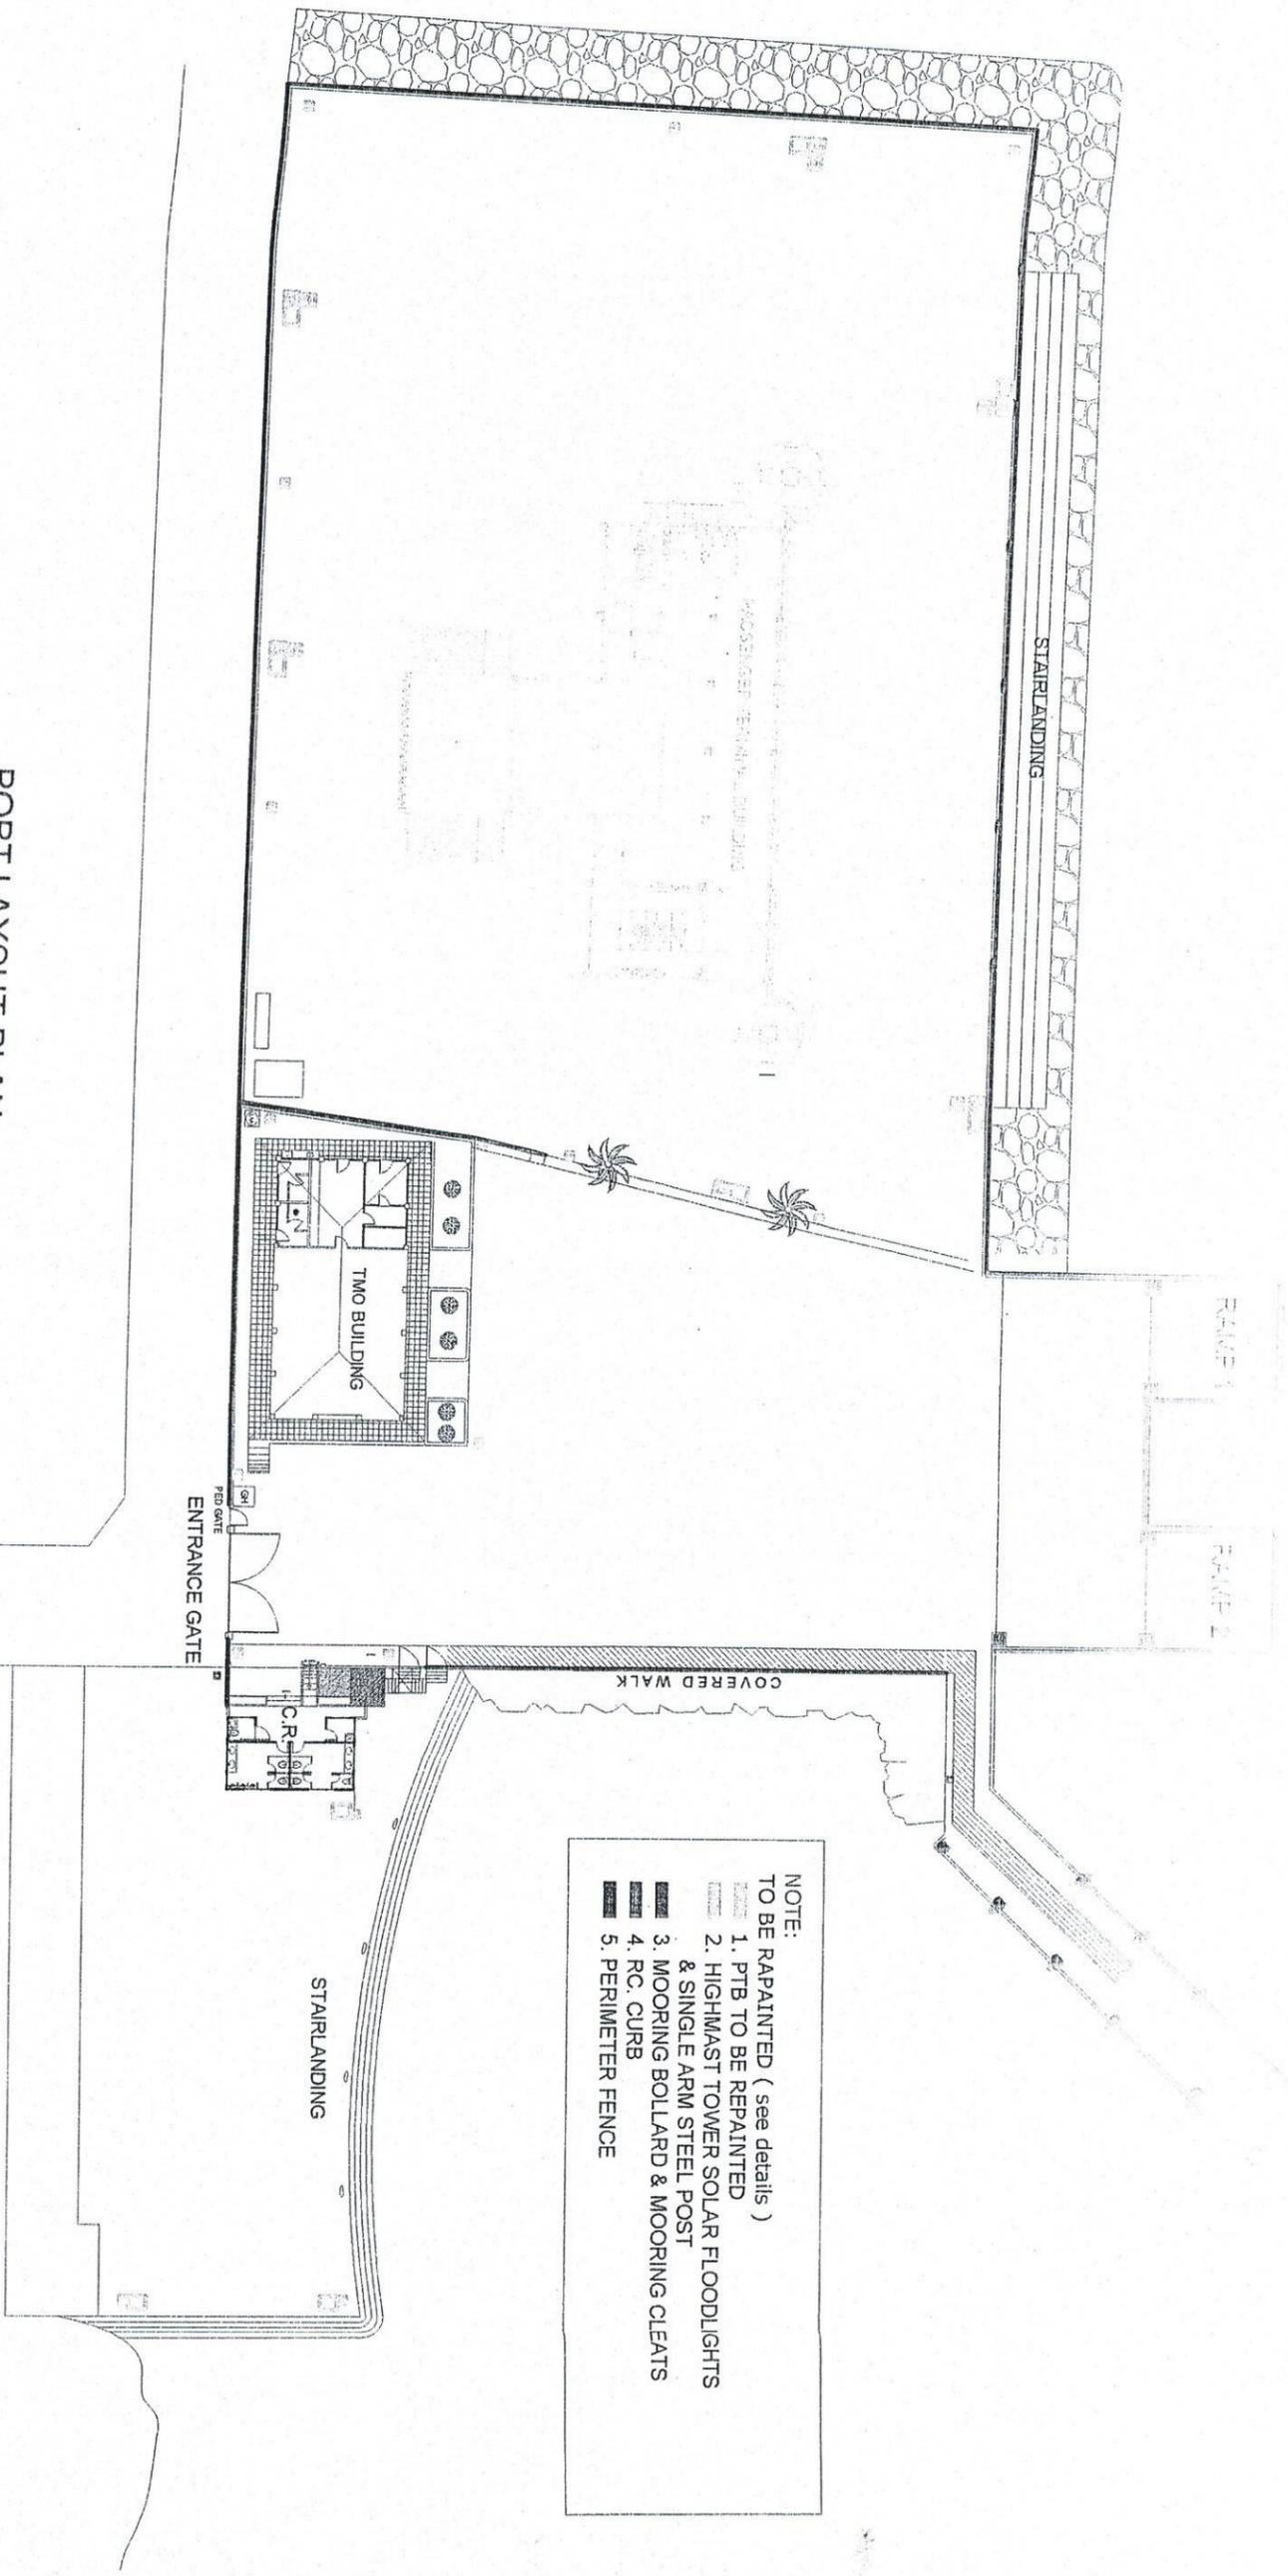

NOTE:
 TO BE RAPAIINTED (see details)

1. PTB TO BE REPAINTED
2. HIGHMAST TOWER SOLAR FLOODLIGHTS & SINGLE ARM STEEL POST
3. MOORING BOLLARD & MOORING CLEATS
4. RC. CURB
5. PERIMETER FENCE

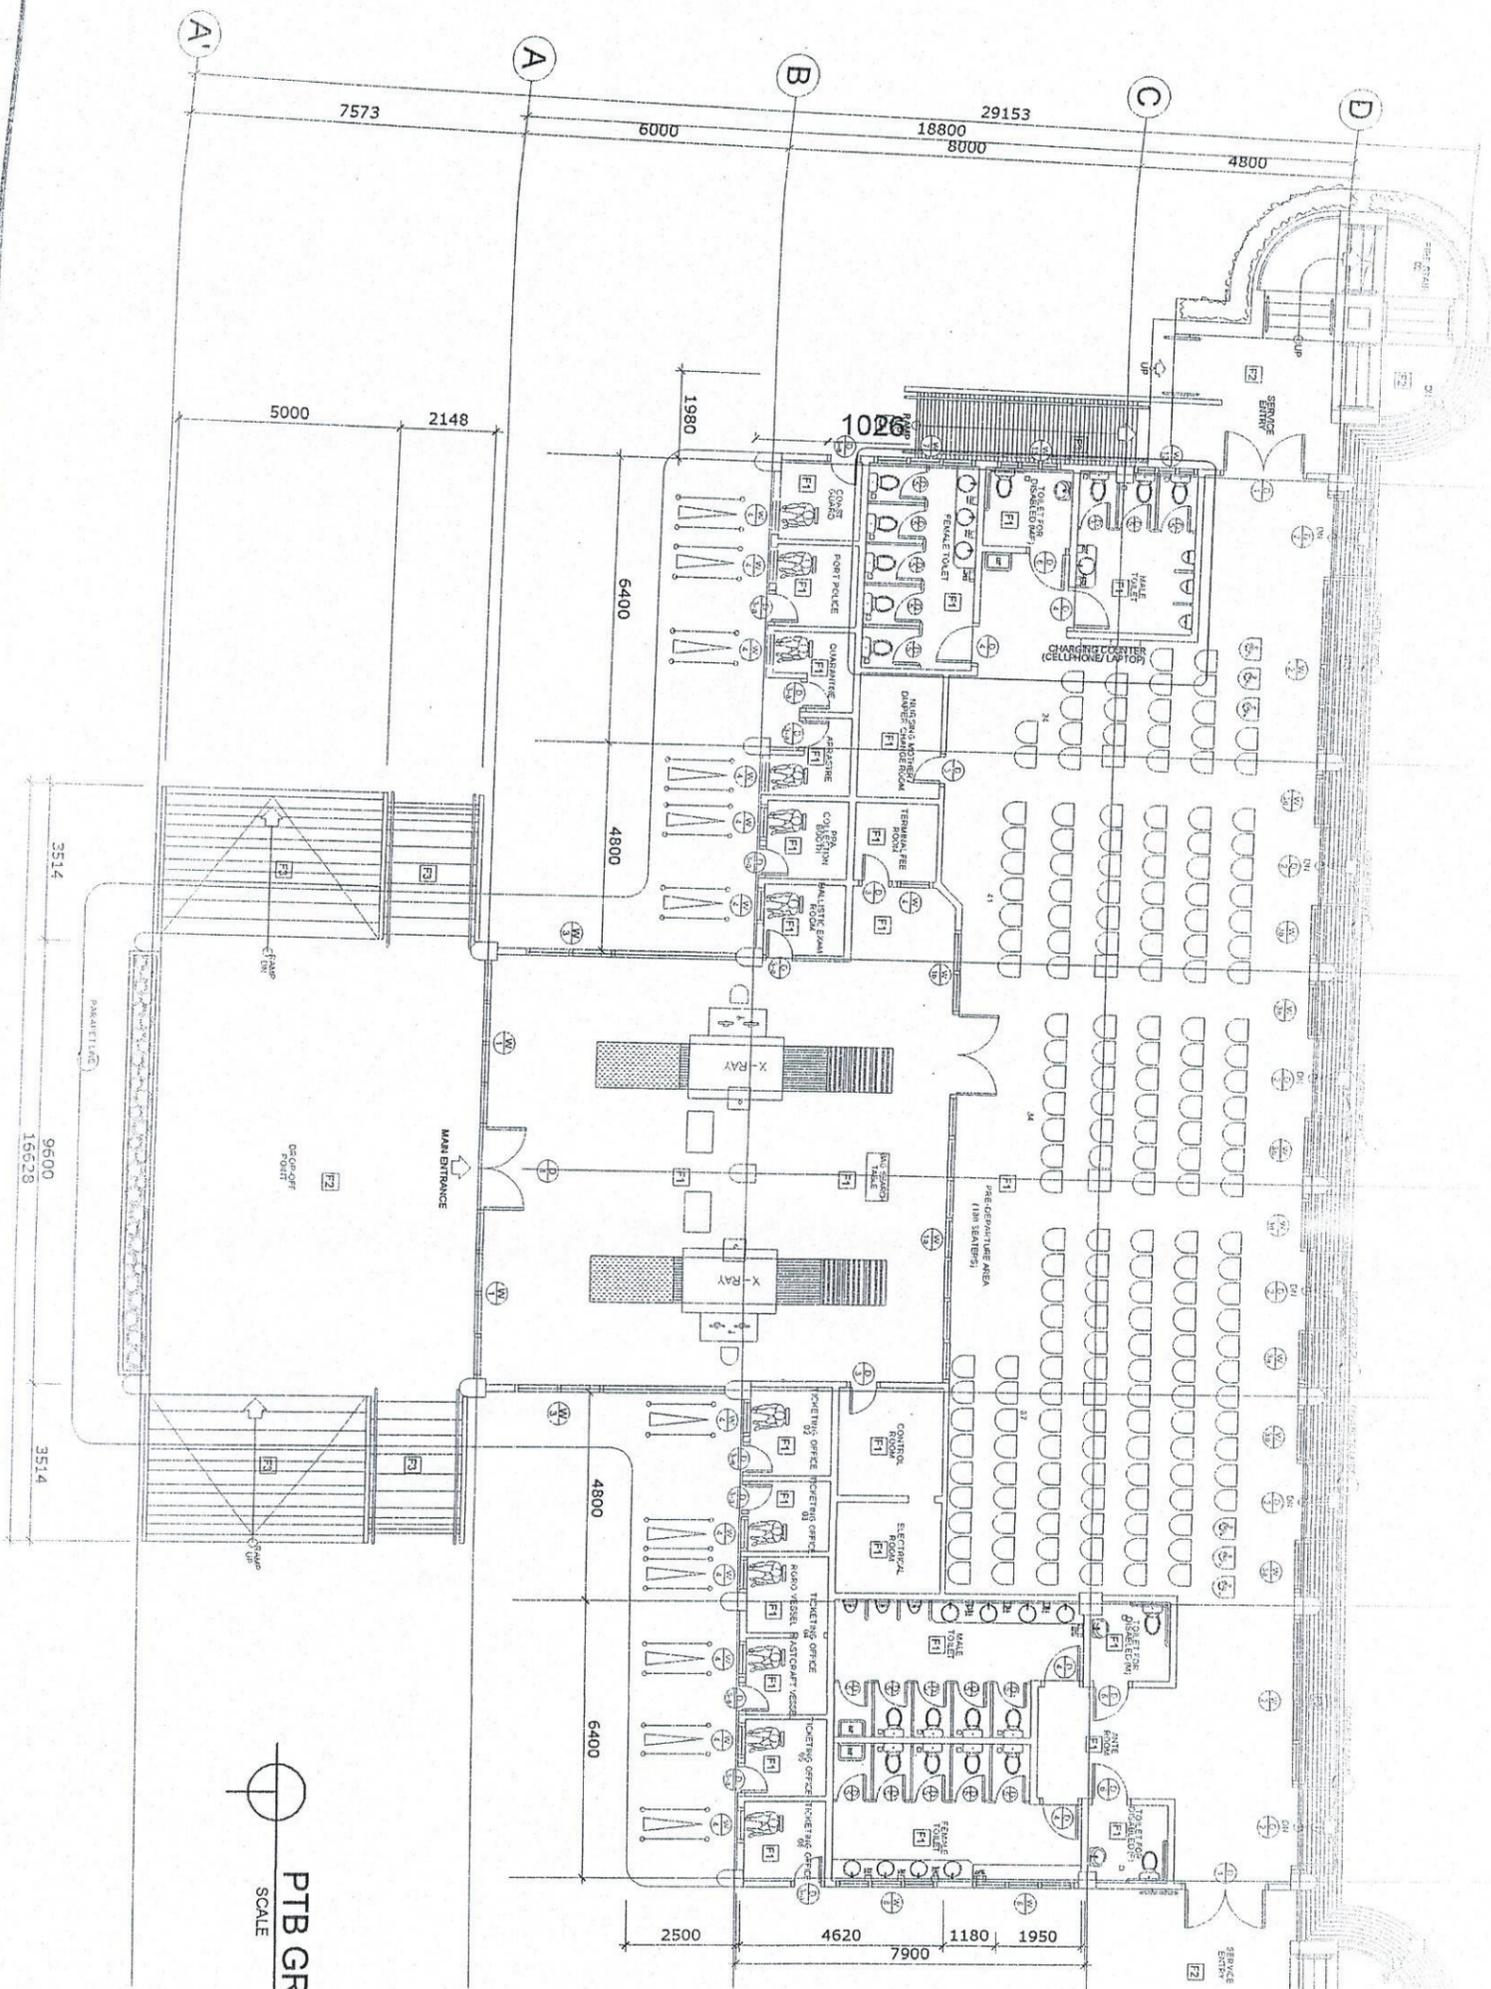


NOTE:
THE COLOR OF THE THEME SHOULD BE THE SAME AS THE PORT OPERATION BUILDING IN THE PORT OF CALAPAN

NOTE:
EXTERIOR WALL OF NEW PASSENGER TERMINAL BUILDING TO BE REPAINTED
*REPAINTING WORKS ON ACP
1. SURFACE PREPARATION
3. USE AUTOMOTIVE PAINT (spray)
*REPAINTING WORKS ON CONCRETE
1. SURFACE PREPARATION
2. USE ELASTOMERIC PAINT

PTB GROUND FLOOR PLAN
SCALE 1:160 M.

PROJECT TITLE: VARIOUS REPAINTING WORKS PORT OF PUERTO GALERA, ORIENTAL MINDORO	SHEET CONTENTS: AS SHOWN	SCALE: AS SHOWN
PREPARED BY: FOMEL C. MALLERA (Draftsman II)	RECOMMENDING APPROVAL BY: AS SHOWN	SHEET NO. 2 OF 13
SUBMITTED BY: JOHN CARLOS E. SANDOZ Office Engineer	APPROVED BY: AS SHOWN	DATE: 10 FEBRUARY 2023
CHECKED/REVIEWED BY: AS SHOWN		
Acting Financial Engineer A		
Division Manager A, ESD		
Division Manager A		


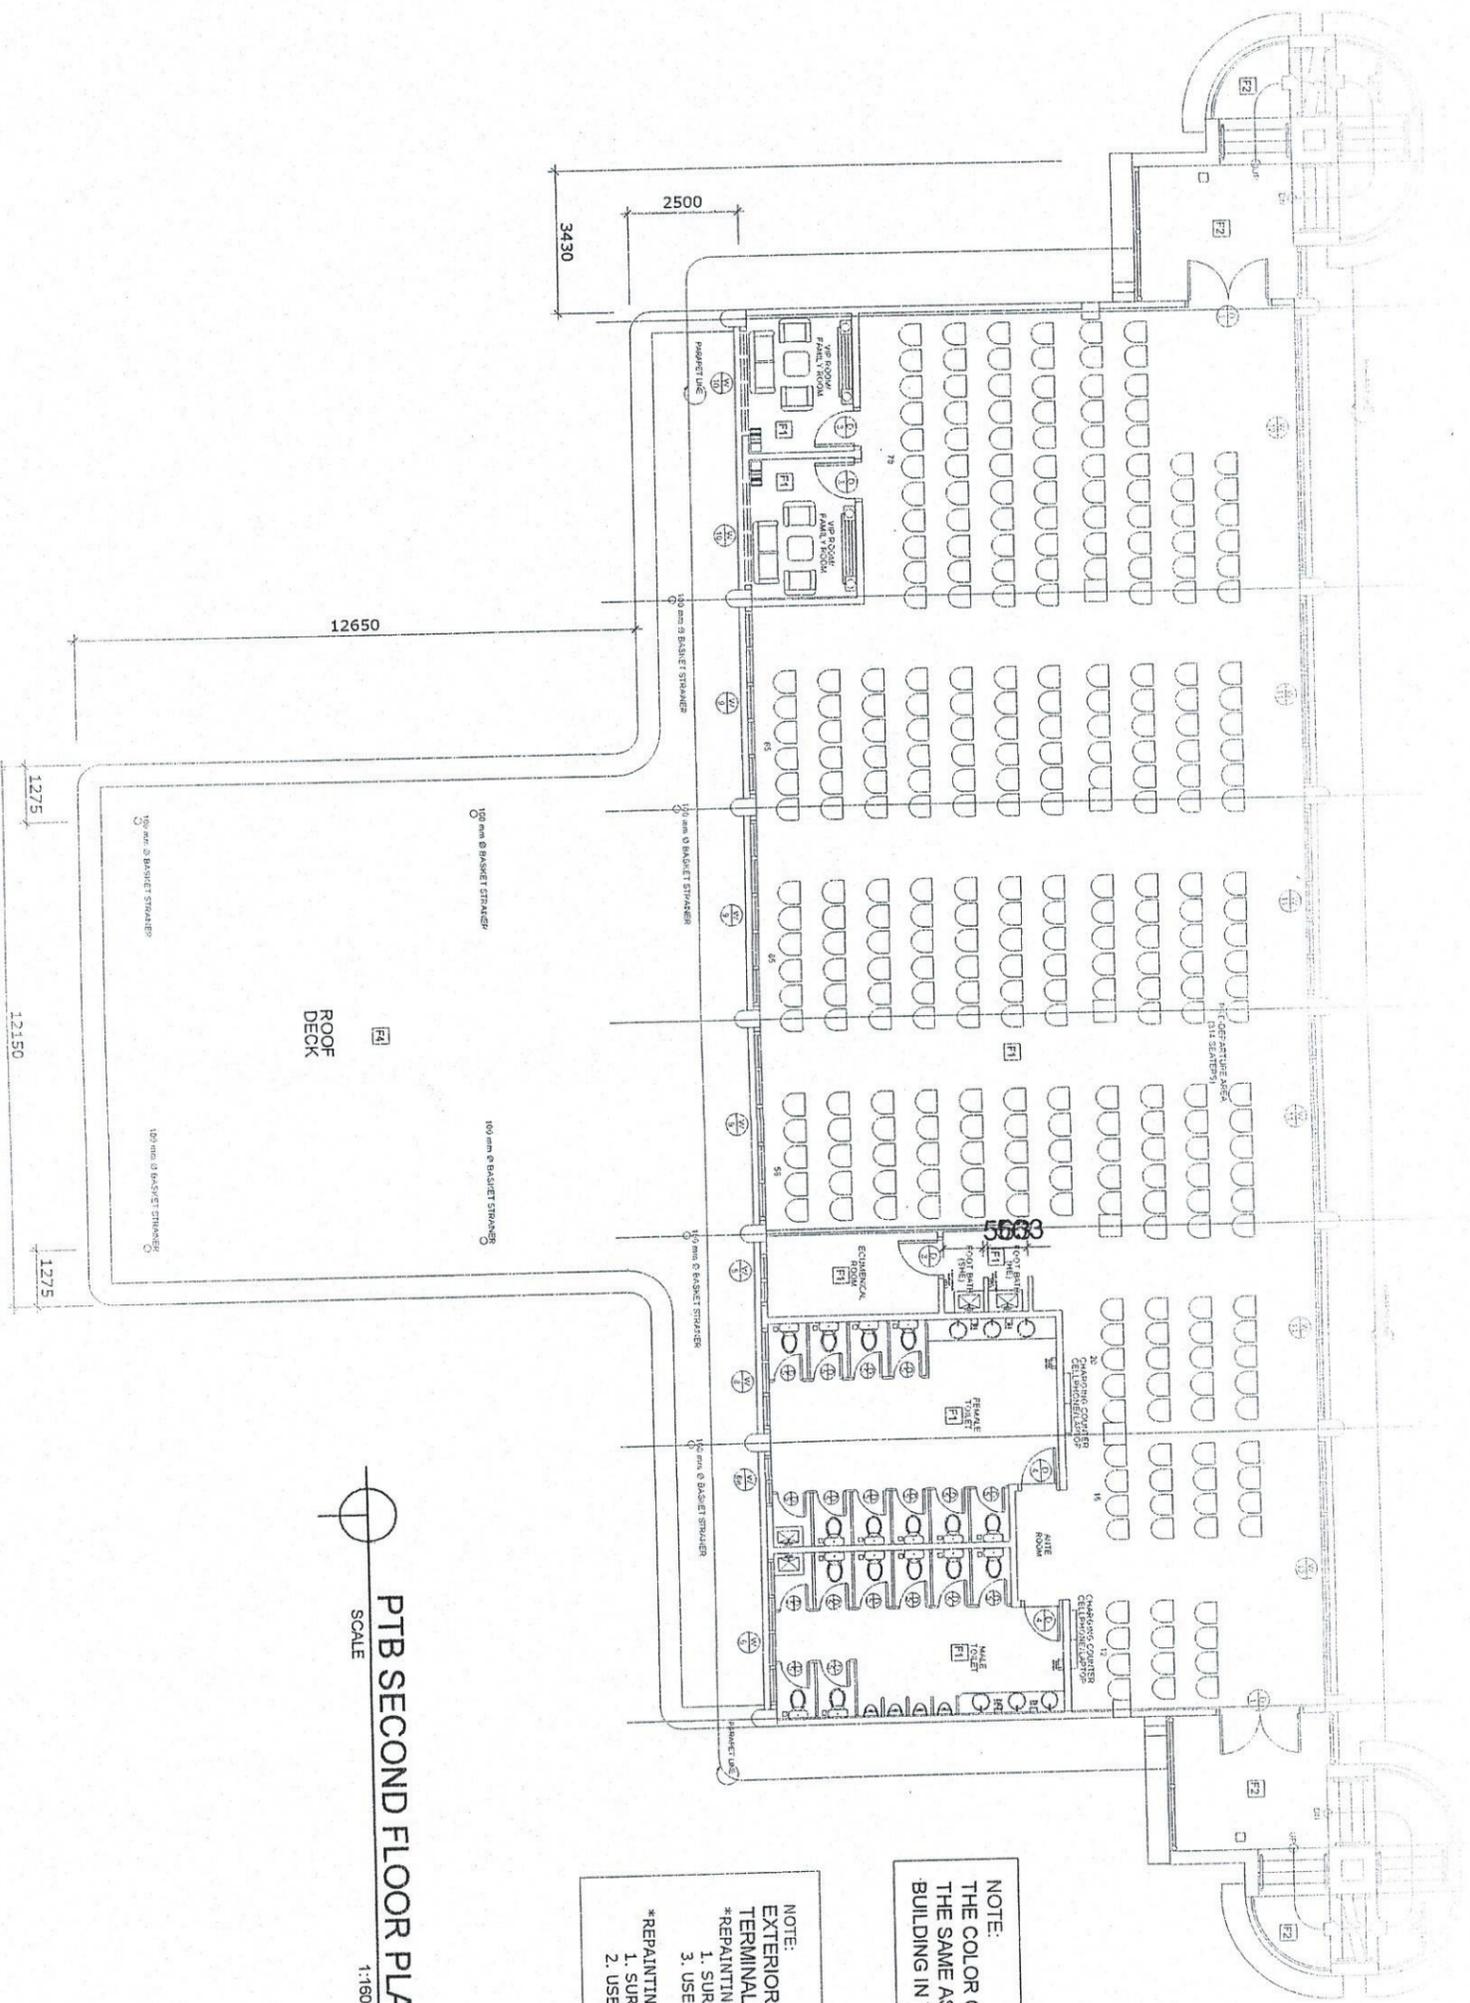


NOTE:
 THE COLOR OF THE THEME SHOULD BE
 THE SAME AS THE PORT OPERATION
 BUILDING IN THE PORT OF CALAPAN


NOTE:
 EXTERIOR WALL OF NEW PASSENGER
 TERMINAL BUILDING TO BE REPAINTED
 *REPAINTING WORKS ON ACP
 1. SURFACE PREPARATION
 3. USE AUTOMOTIVE PAINT (spray)
 *REPAINTING WORKS ON CONCRETE
 1. SURFACE PREPARATION
 2. USE ELASTOMERIC PAINT

PTB SECOND FLOOR PLAN
 SCALE 1:160 M.

PROJECT TITLE: VARIOUS REPAINTING WORKS PORT OF FUERTO SALER, ORIENTAL MINDORO	CHECKED / REVIEWED BY: ROBERTO S. MANTING Acting Principal Engineer, A	RECOMMENDING APPROVAL BY: MARCOSANTOS F. DIMALALIG Division Manager, A, ESD	SHEET CONTENTS: AS SHOWN	SCALE: AS SHOWN
PREPARED BY: ROBERTO S. MANTING Draftsman II	SUBMITTED BY: ROBERTO S. MANTING Office Engineer	APPROVED BY: E. M. MANTING Port Manager, A	SHEET NO. 1 OF 16	DATE: 10 FEBRUARY, 2023

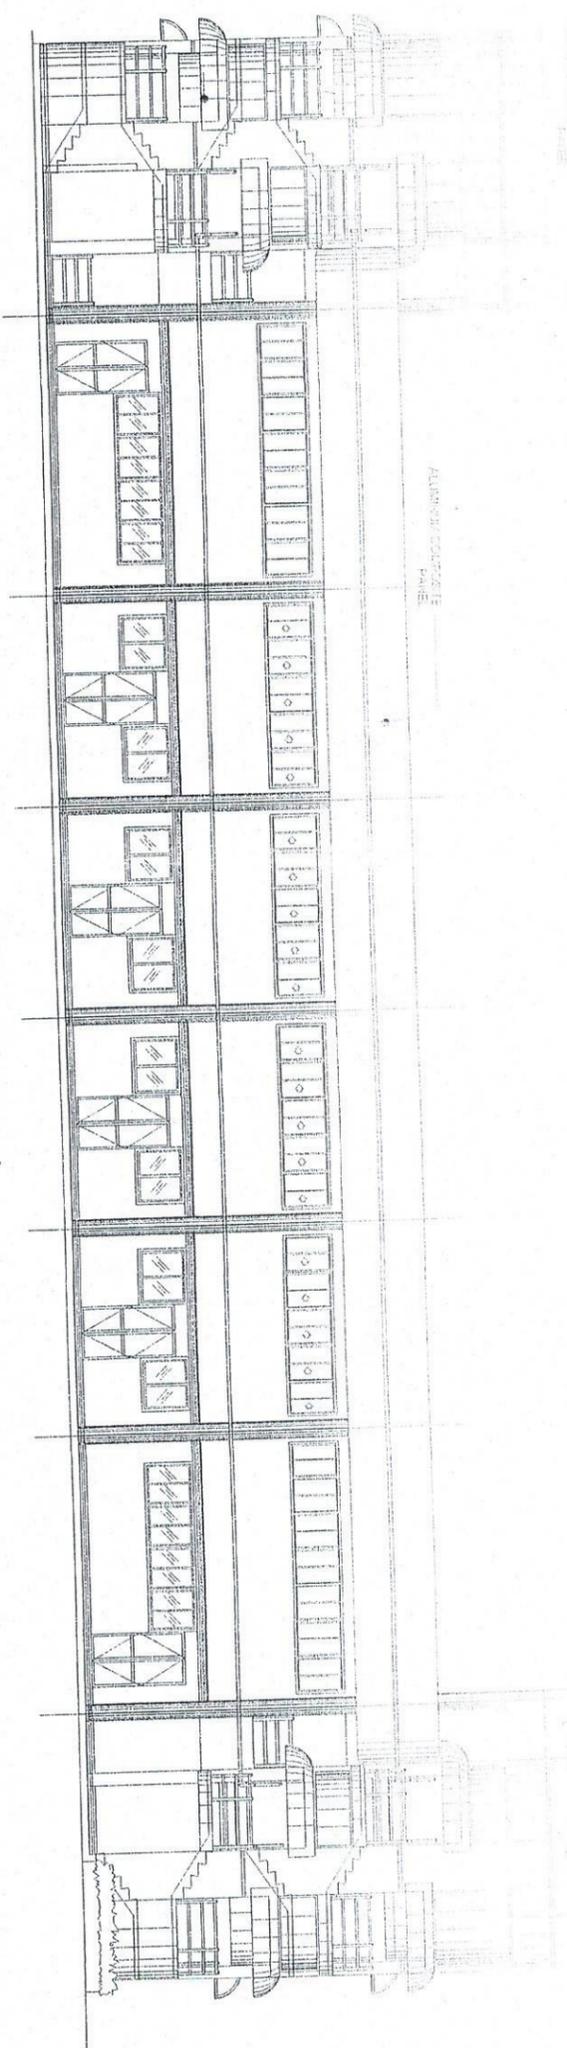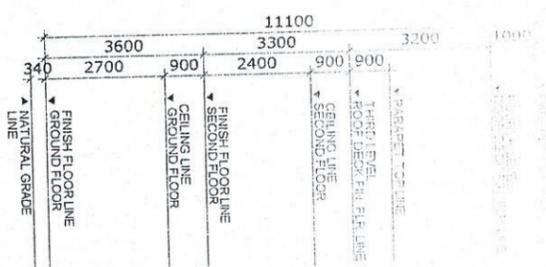

REAR ELEVATION
SCALE 1:150 M.

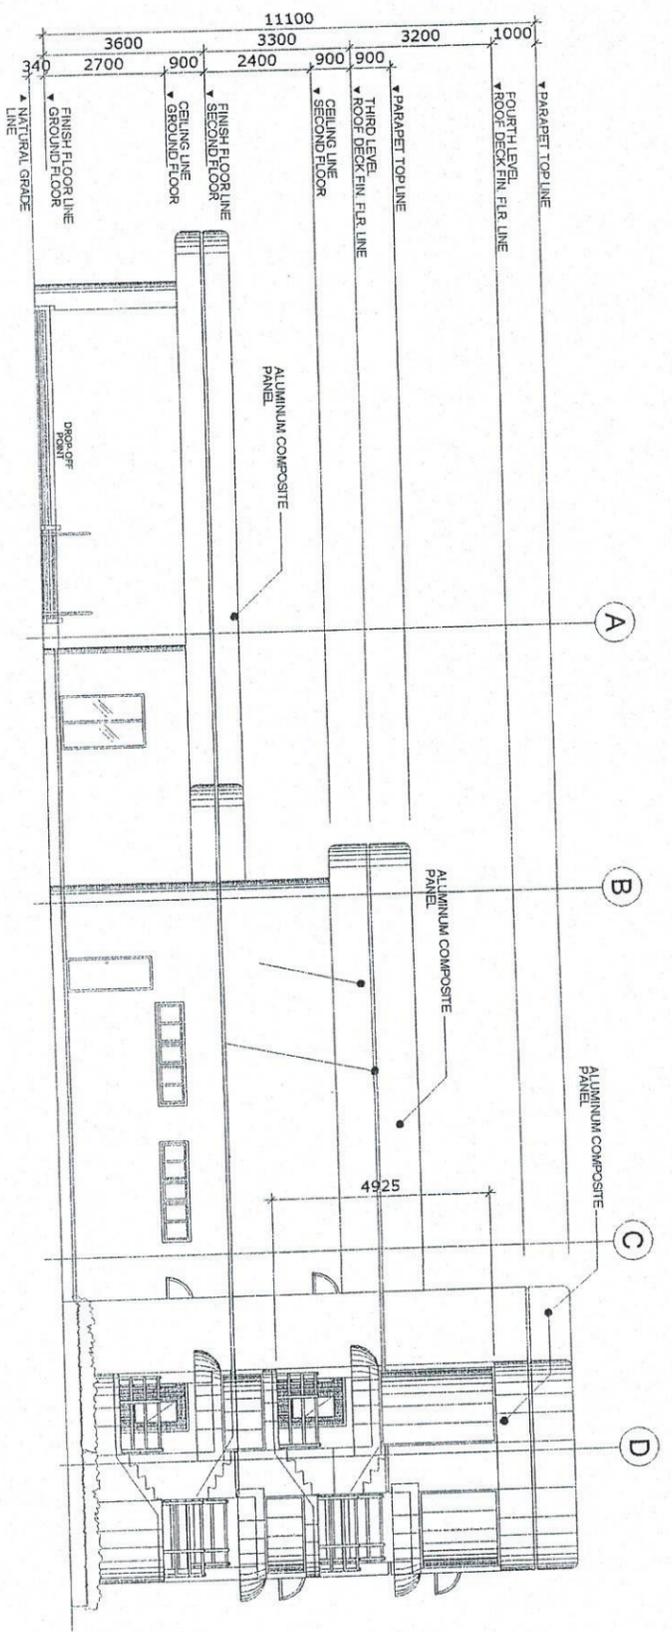

RIGHT ELEVATION
SCALE 1:150 M.


NOTE:
EXTERIOR WALL OF NEW PASSENGER
TERMINAL BUILDING TO BE REPAINTED
*REPAINTING WORKS ON ACP
1. SURFACE PREPARATION
3. USE AUTOMOTIVE PAINT (spray)
*REPAINTING WORKS ON CONCRETE
1. SURFACE PREPARATION
2. USE ELASTOMERIC PAINT

NOTE:
THE COLOR OF THE THEME SHOULD BE
THE SAME AS THE PORT OPERATION
BUILDING IN THE PORT OF CALAPAN

PROJECT TITLE	VARIOUS REPAINTING WORKS PORT OF PUERTO GALERA, ORIENTAL MINDORO	
PREPARED BY	DESIGNED BY	CHECKED / REVIEWED BY
DATE	10 FEBRUARY 2023	
SHEET NO.	5 OF 15	
SHEET CONTENTS	AS SHOWN	SCALE: AS SHOWN

REPAIRS - SINGLE ARM STEEL POST TO BE REPAINTED (SEE DETAILS)

NOTE: HIGH MAST TOWER TO BE REPAINTED (SEE DETAILS)
6 sets

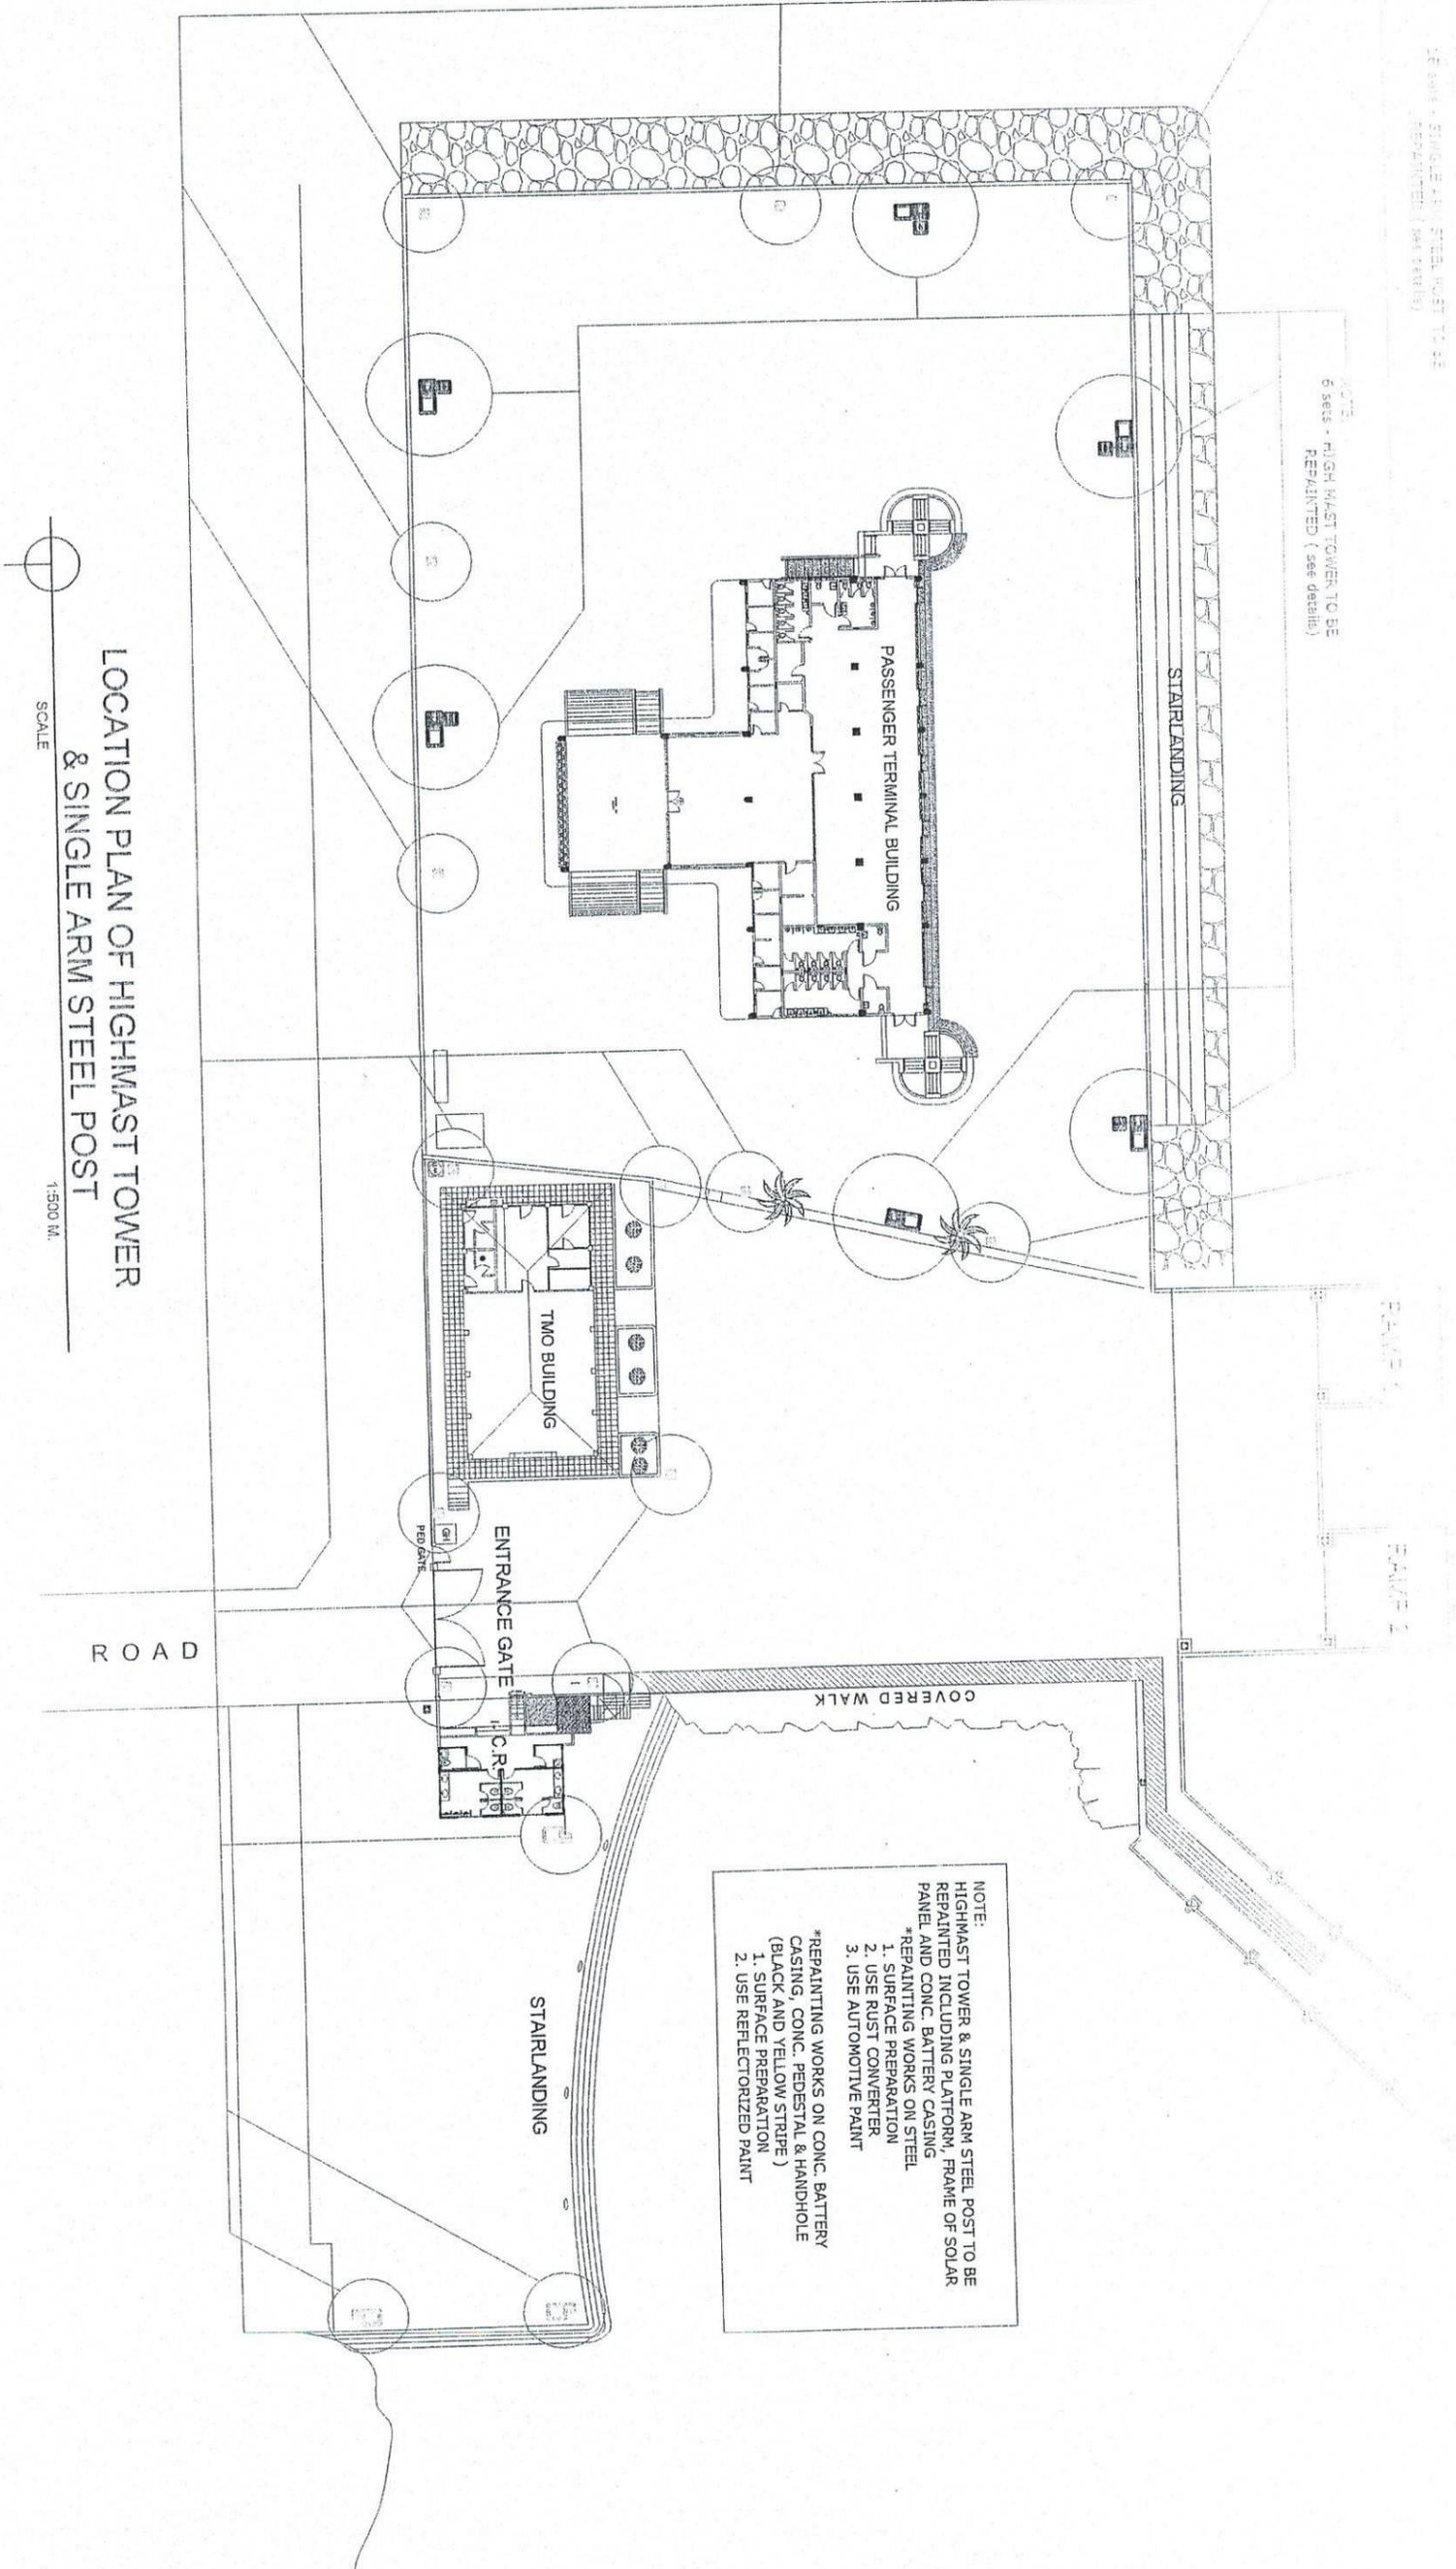

NOTE:
HIGHMAST TOWER & SINGLE ARM STEEL POST TO BE REPAINTED INCLUDING PLATFORM, FRAME OF SOLAR PANEL AND CONC. BATTERY CASING

*REPAINTING WORKS ON STEEL

1. SURFACE PREPARATION
2. USE RUST CONVERTER
3. USE AUTOMOTIVE PAINT


*REPAINTING WORKS ON CONC. BATTERY CASING, CONC. PEDestal & HANDHOLE (BLACK AND YELLOW STRIPE)

1. SURFACE PREPARATION
2. USE REFLECTORIZED PAINT

LOCATION PLAN OF HIGHMAST TOWER
& SINGLE ARM STEEL POST

SCALE
1:500 M

PROJECT TITLE: VARIOUS REPAINTING WORKS PORT OF QUEENSLAND, QUEENSLAND, AUSTRALIA	DESIGNED BY: RICHARD J. WILSON Director	CHECKED BY: RICHARD J. WILSON Acting Principle Engineer / A	APPROVED BY: RICHARD J. WILSON Acting Principle Engineer / A
PREPARED BY: RICHARD J. WILSON Director	SUBMITTED BY: RICHARD J. WILSON Director	RECOMMENDING APPROVAL BY: RICHARD J. WILSON Director	APPROVED BY: RICHARD J. WILSON Acting Principle Engineer / A
SHEET CONTENTS: AS SHOWN		SCALE: AS SHOWN	
SHEET NO. 7 of 13		DATE: 10 FEBRUARY 2023	

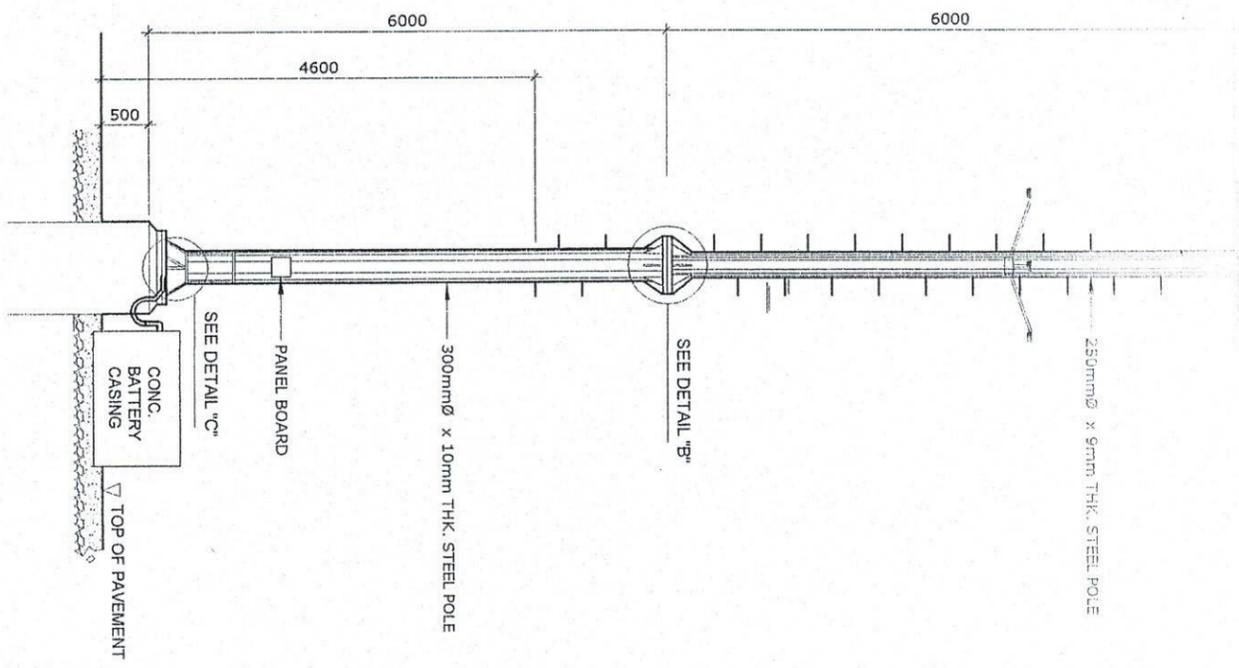

DETAIL OF HIGHMAST TOWER
SOLAR POWER FLOODLIGHTS
SCALE 1:75M


NOTE:
HIGHMAST TOWER & SINGLE ARM STEEL POST TO BE REPAINTED INCLUDING PLATFORM, FRAME OF SOLAR PANEL AND CONC. BATTERY CASING

*REPAINTING WORKS ON STEEL



1. SURFACE PREPARATION
2. USE RUST CONVERTER
3. USE AUTOMOTIVE PAINT

*REPAINTING WORKS ON CONC. BATTERY CASING, CONC. PEDESTAL & HANDHOLE (BLACK AND YELLOW STRIPE)

1. SURFACE PREPARATION
2. USE REFLECTORIZED PAINT

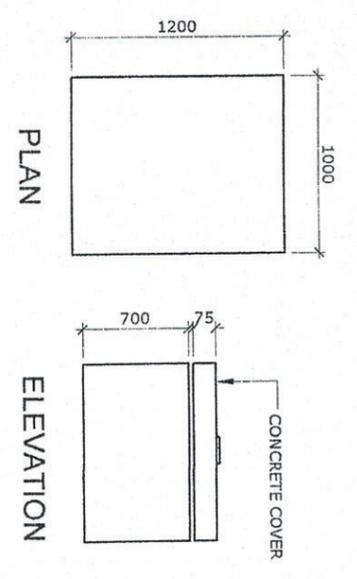


TYPICAL DETAIL OF
CONCRETE BATTERY CASING
SCALE 1:350 M

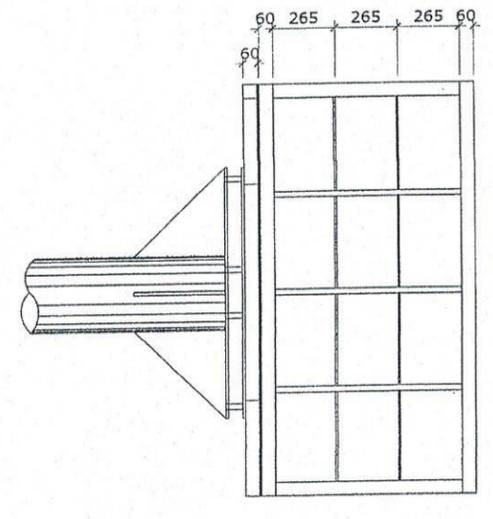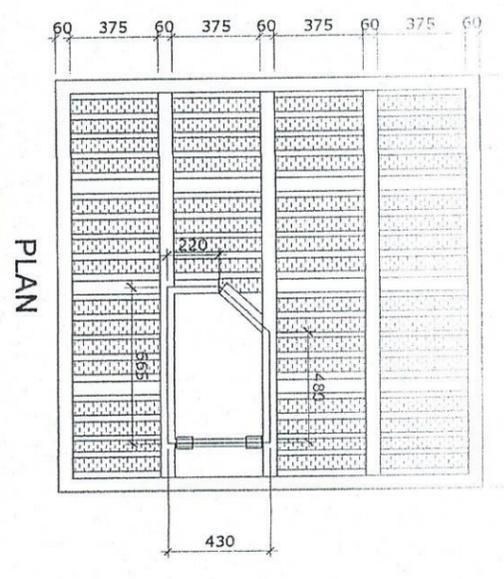

TYP. ELEVATION
PLATFORM FRAME DETAIL
SCALE 1:300 M

PROJECT TITLE:	VARIOUS REPAINTING WORKS		SHEET CONTENTS:	SCALE:
CLIENT:	PORT OF PUERTO RICO, SALEM, ORIENTAL MINICORP		AS SHOWN	AS SHOWN
DESIGNED BY:	DESIGNED BY:	RECOMMENDING APPROVAL BY:	SHEET NO.:	DATE:
Checked/Reviewed By:	Checked/Reviewed By:	Approved By:	8 of 15	10 FEBRUARY 2003
Project Engineer:	Project Engineer:	Division Manager:		
Division Manager:	Division Manager:	Port Manager:		

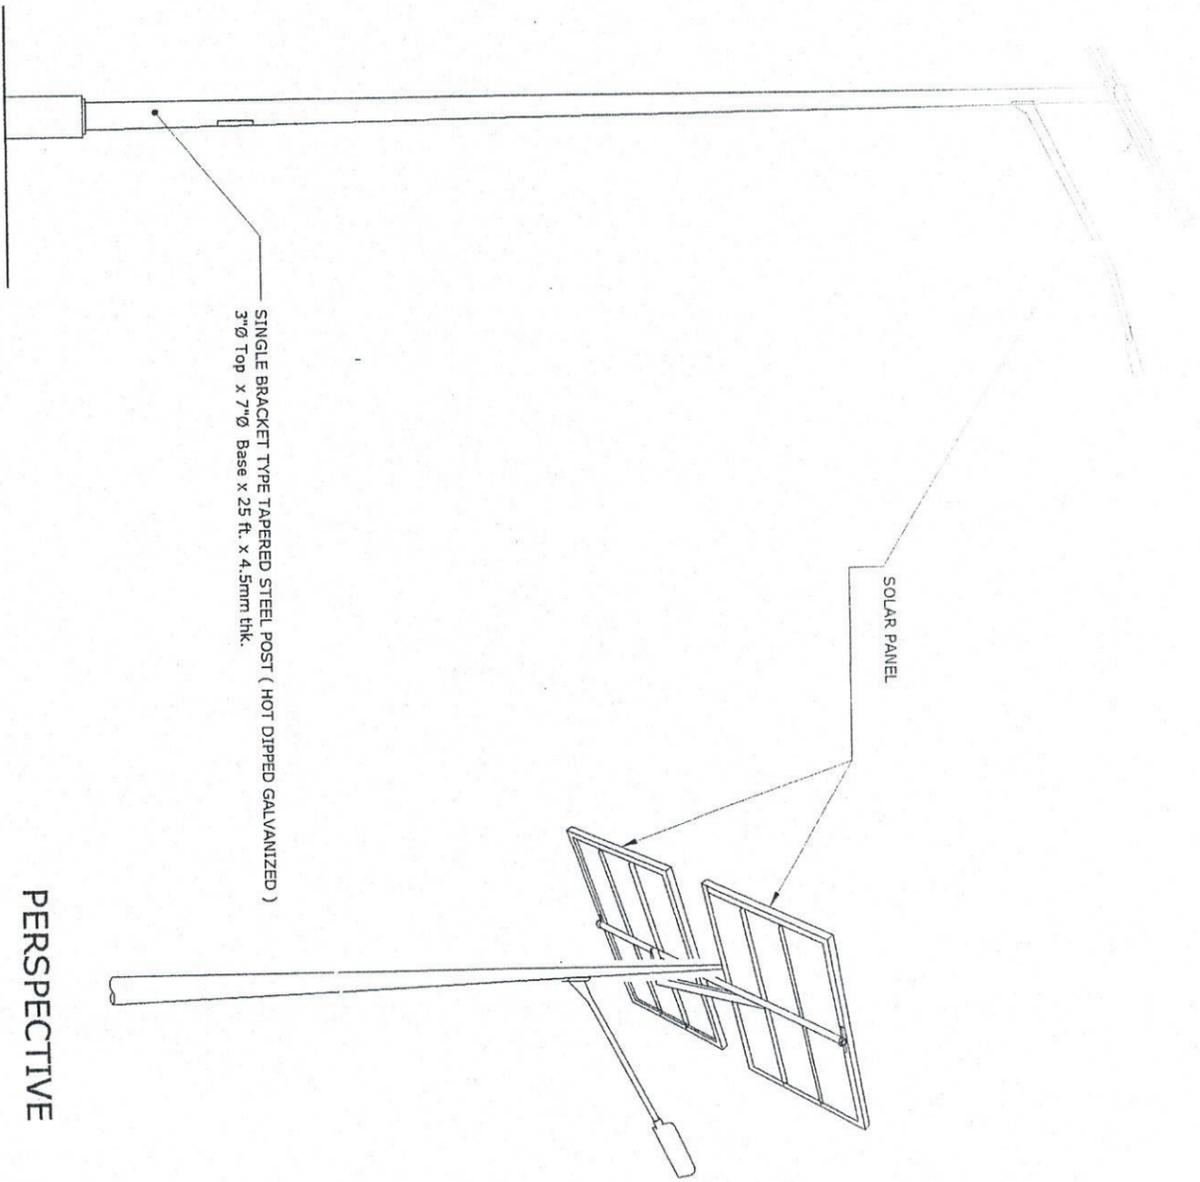


PERSPECTIVE

DETAIL OF SINGLE ARM
STEEL POST

SCALE

NTS

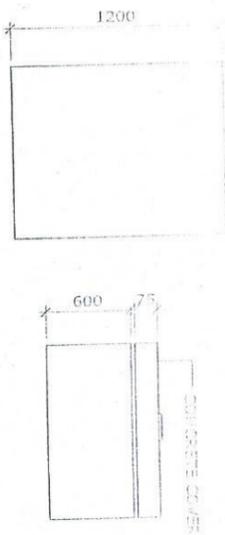

PLAN

ELEVATION

TYPICAL DETAIL OF
CONCRETE BATTERY CASING

SCALE

1:50 M.

NOTE:
HIGHMAST TOWER & SINGLE ARM STEEL POST TO BE REPAINTED INCLUDING PLATFORM, FRAME OF SOLAR PANEL AND CONC. BATTERY CASING

*REPAINTING WORKS ON STEEL

1. SURFACE PREPARATION
2. USE RUST CONVERTER
3. USE AUTOMOTIVE PAINT

*REPAINTING WORKS ON CONC. BATTERY CASING, CONC. PEDESTAL & HANDHOLE (BLACK AND YELLOW STRIPE)

1. SURFACE PREPARATION
2. USE REFLECTORIZED PAINT


PROJECT TITLE: VARIOUS REPAINTING WORKS

PORT OF PUERTO GALERA, ORIENTAL MINDORO

PREPARED BY: EUGENE S. MENDOZA Draftsman II	SUBMITTED BY: EUGENE S. MENDOZA Office Engineer	CHECKED / REVIEWED BY: EUGENE S. MENDOZA Acting Site/In-charge Engineer A	RECOMMENDING APPROVAL BY: EUGENE S. MENDOZA Division Manager A, ESD	APPROVED BY: EUGENE S. MENDOZA Port Manager A
SHEET CONTENTS: AS SHOWN		SCALE: AS SHOWN		SHEET NO.: E of 13
				DATE: 10 FEBRUARY 2023

7 SETS OF MOORING
CLEATS TO BE REPAINTED

NOTE:
7 SETS OF MOORING
CLEATS TO BE REPAINTED

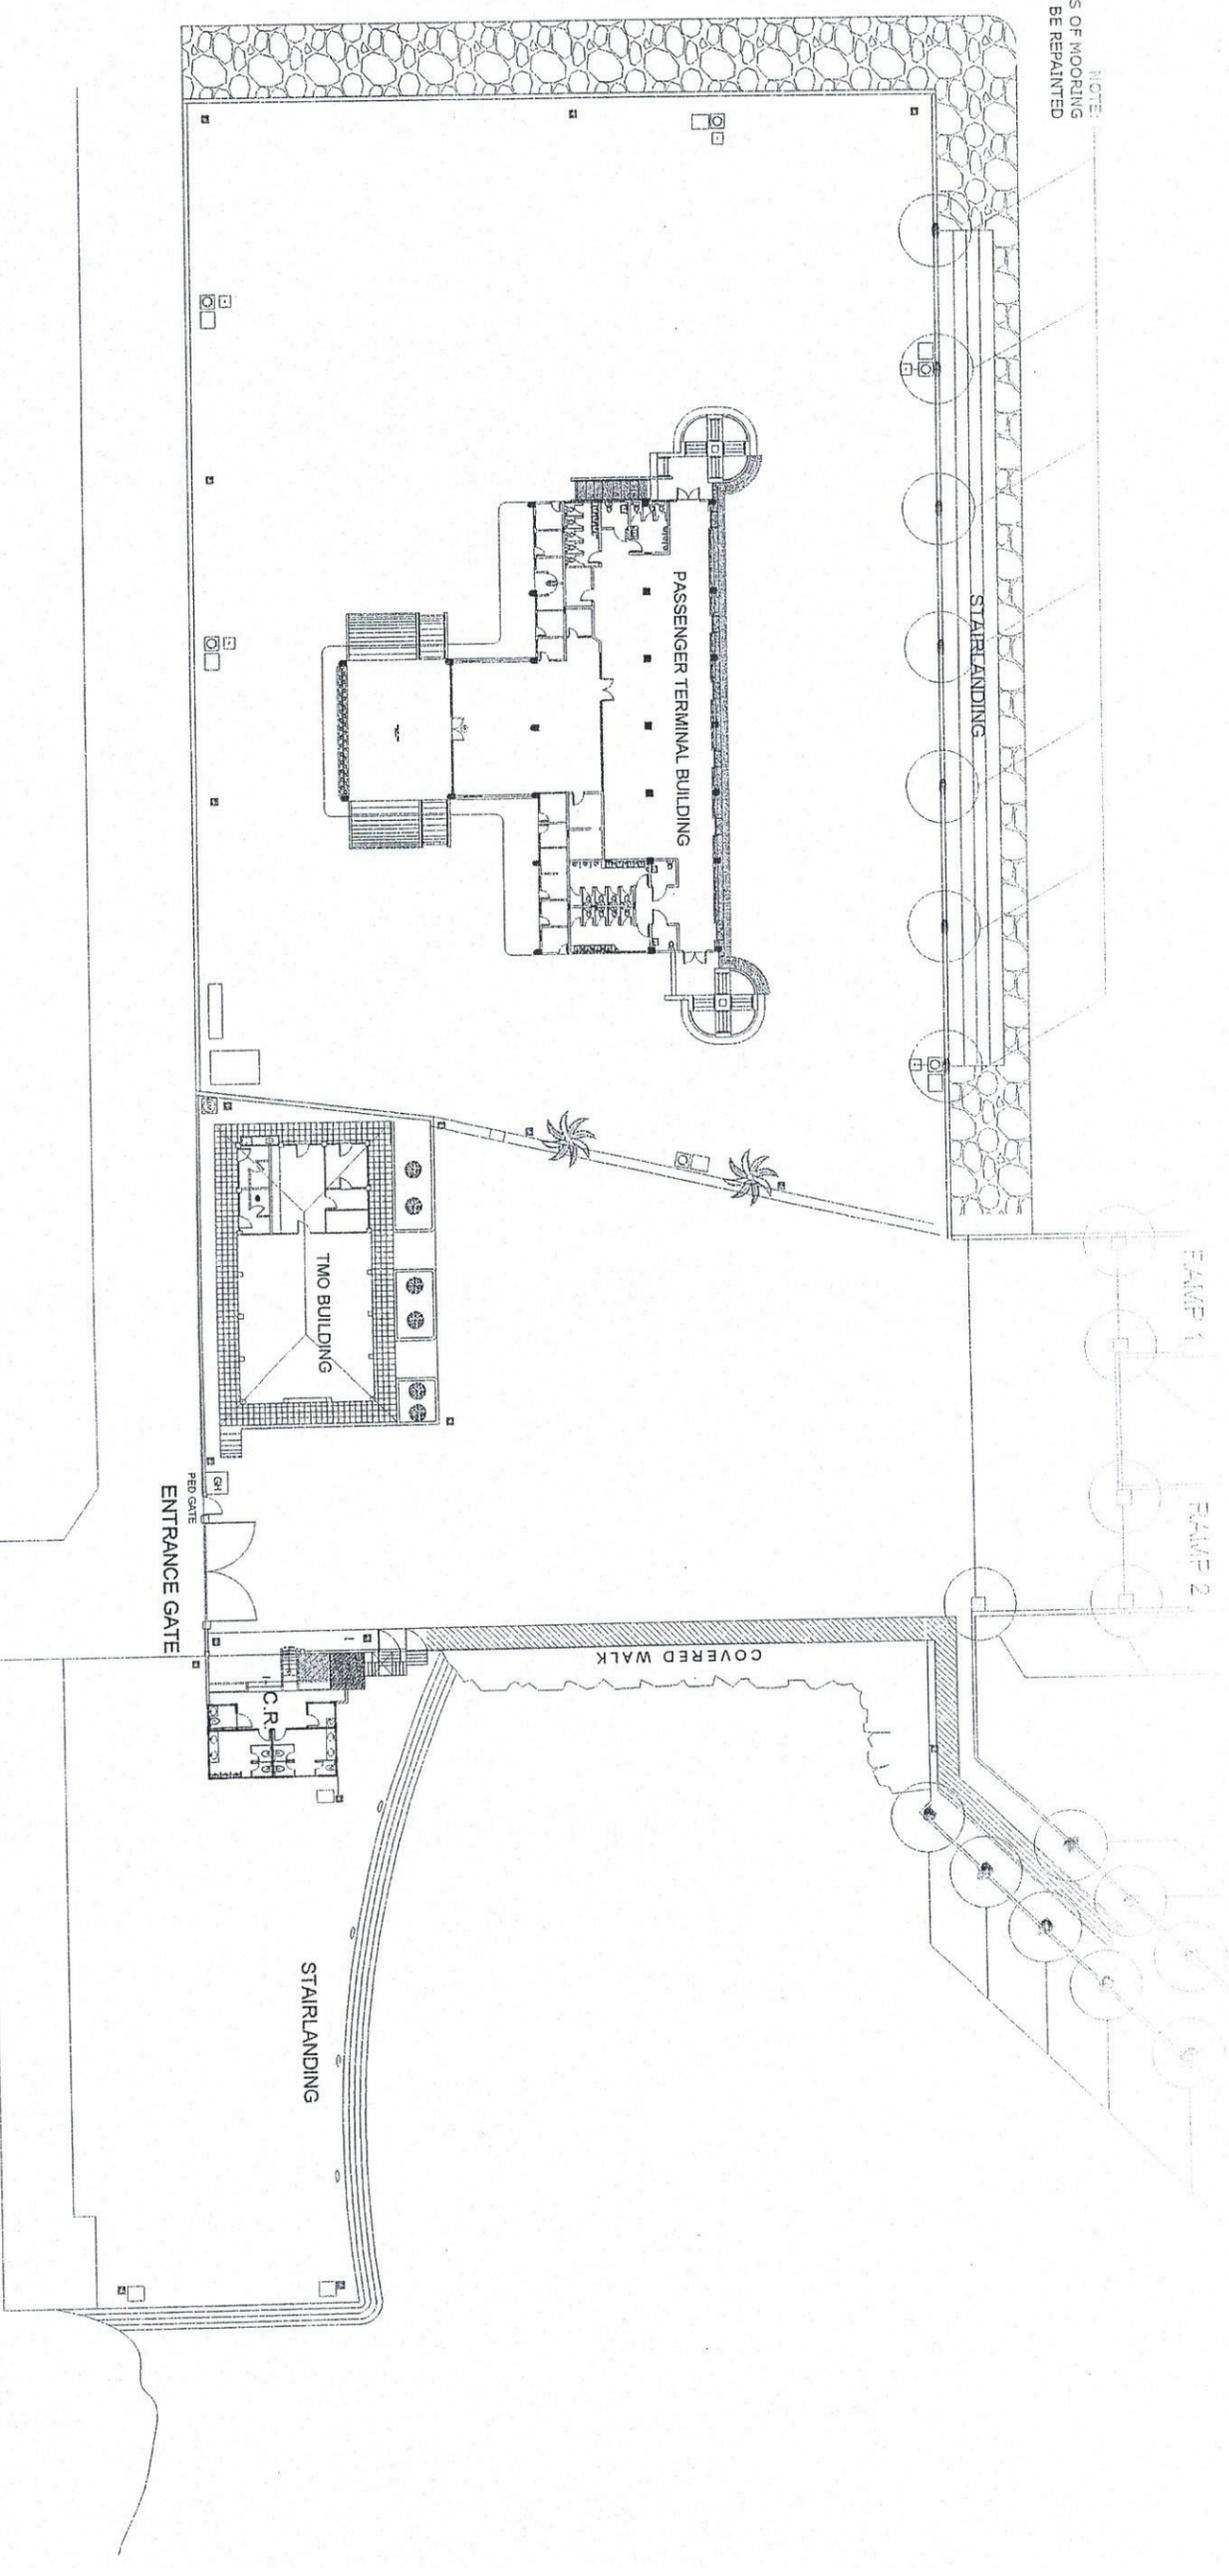

PROJECT TITLE: VARIOUS REPAIRING WORKS

PORT OF PEIPETO GALLERIA, ORIENTAL MANDORAO


PREPARED BY: <i>[Signature]</i> Charistomaili	SUBMITTED BY: <i>[Signature]</i> Charistomaili	DESIGNED BY: <i>[Signature]</i> Charistomaili	RECOMMENDING APPROVAL: <i>[Signature]</i> Charistomaili	APPROVED BY: <i>[Signature]</i> Charistomaili
Checked Engineer	Checked Engineer	Checked Engineer	Checked Engineer	Checked Engineer

SHEET CONTENTS: AS SHOWN


SHEET NO. 10 of 13

SCALE: AS SHOWN


DATE: 10 FEBRUARY 2010

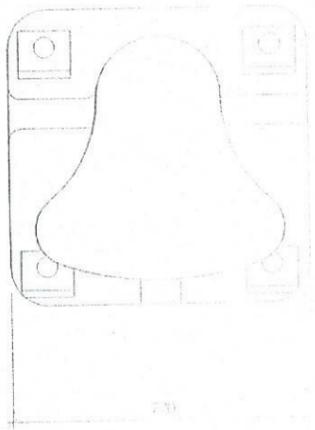


PLAN

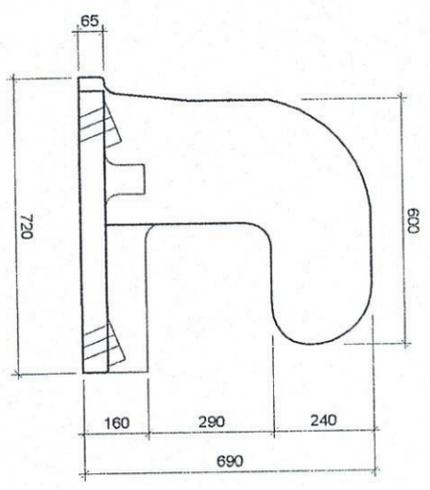


SECTION

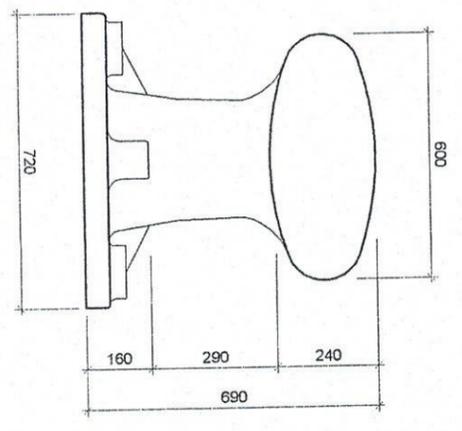


ELEVATION

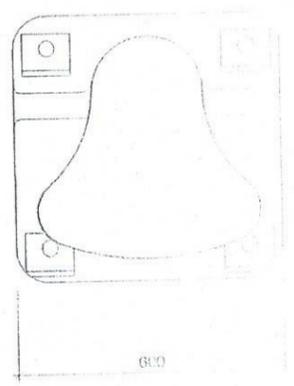


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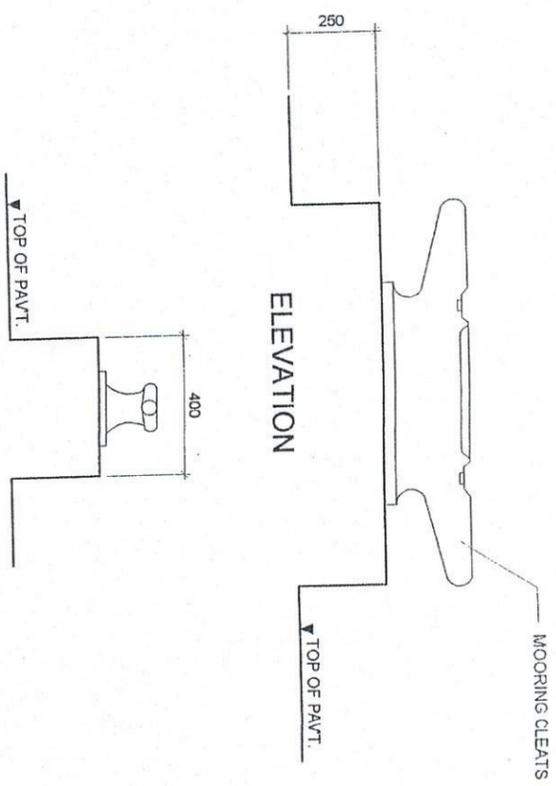
SECTION

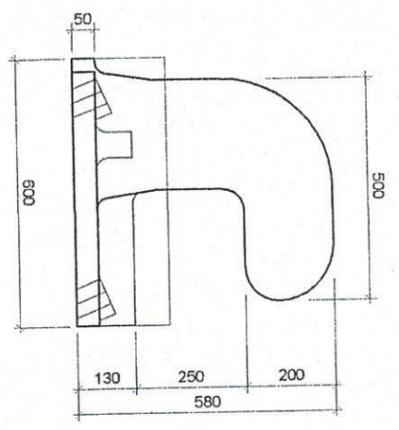

ELEVATION

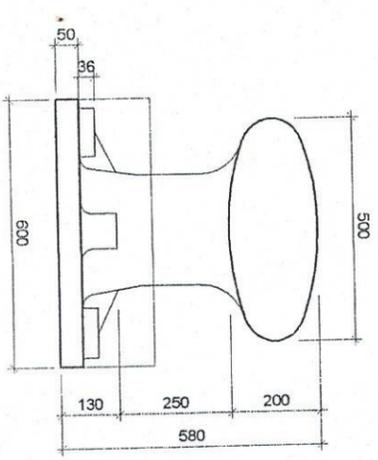


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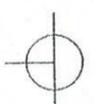
SIDE ELEVATION

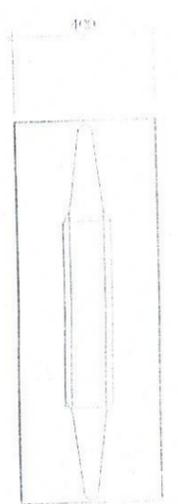MOORING CLEATS DETAILS
SCALE 1:20 M.

NOTE:
REPAINTING WORKS ON STEEL
1. SURFACE PREPARATION
2. USE RUST CONVERTER
3. USE AUTOMOTIVE PAINT
REPAINTING WORKS ON CONCRETE
(BLACK & YELLOW STRIPE)
1. SURFACE PREPARATION
2. USE REFLECTORIZED PAINT



DETAIL OF 25 TONS
MOORING BOLLARD
SCALE N.T.S.

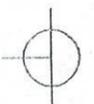

DETAIL OF 15 TONS
MOORING BOLLARD
SCALE N.T.S.

PROJECT TITLE:

VARIOUS REPAINTING WORKS
PORT OF PUERTO GALERA, ORIENTAL MINDORO

PREPARED BY:

SUBMITTED BY:

CHECKED BY:

RECOMMENDING APPROVAL BY:

APPROVED BY:

SHEET CONTENTS:

SCALE:


AS SHOWN

AS SHOWN


SHEET NO. 11 OF 13

10 FEBRUARY 2023

LOCATION PLAN OF PERIMETER FENCE & RC CURB

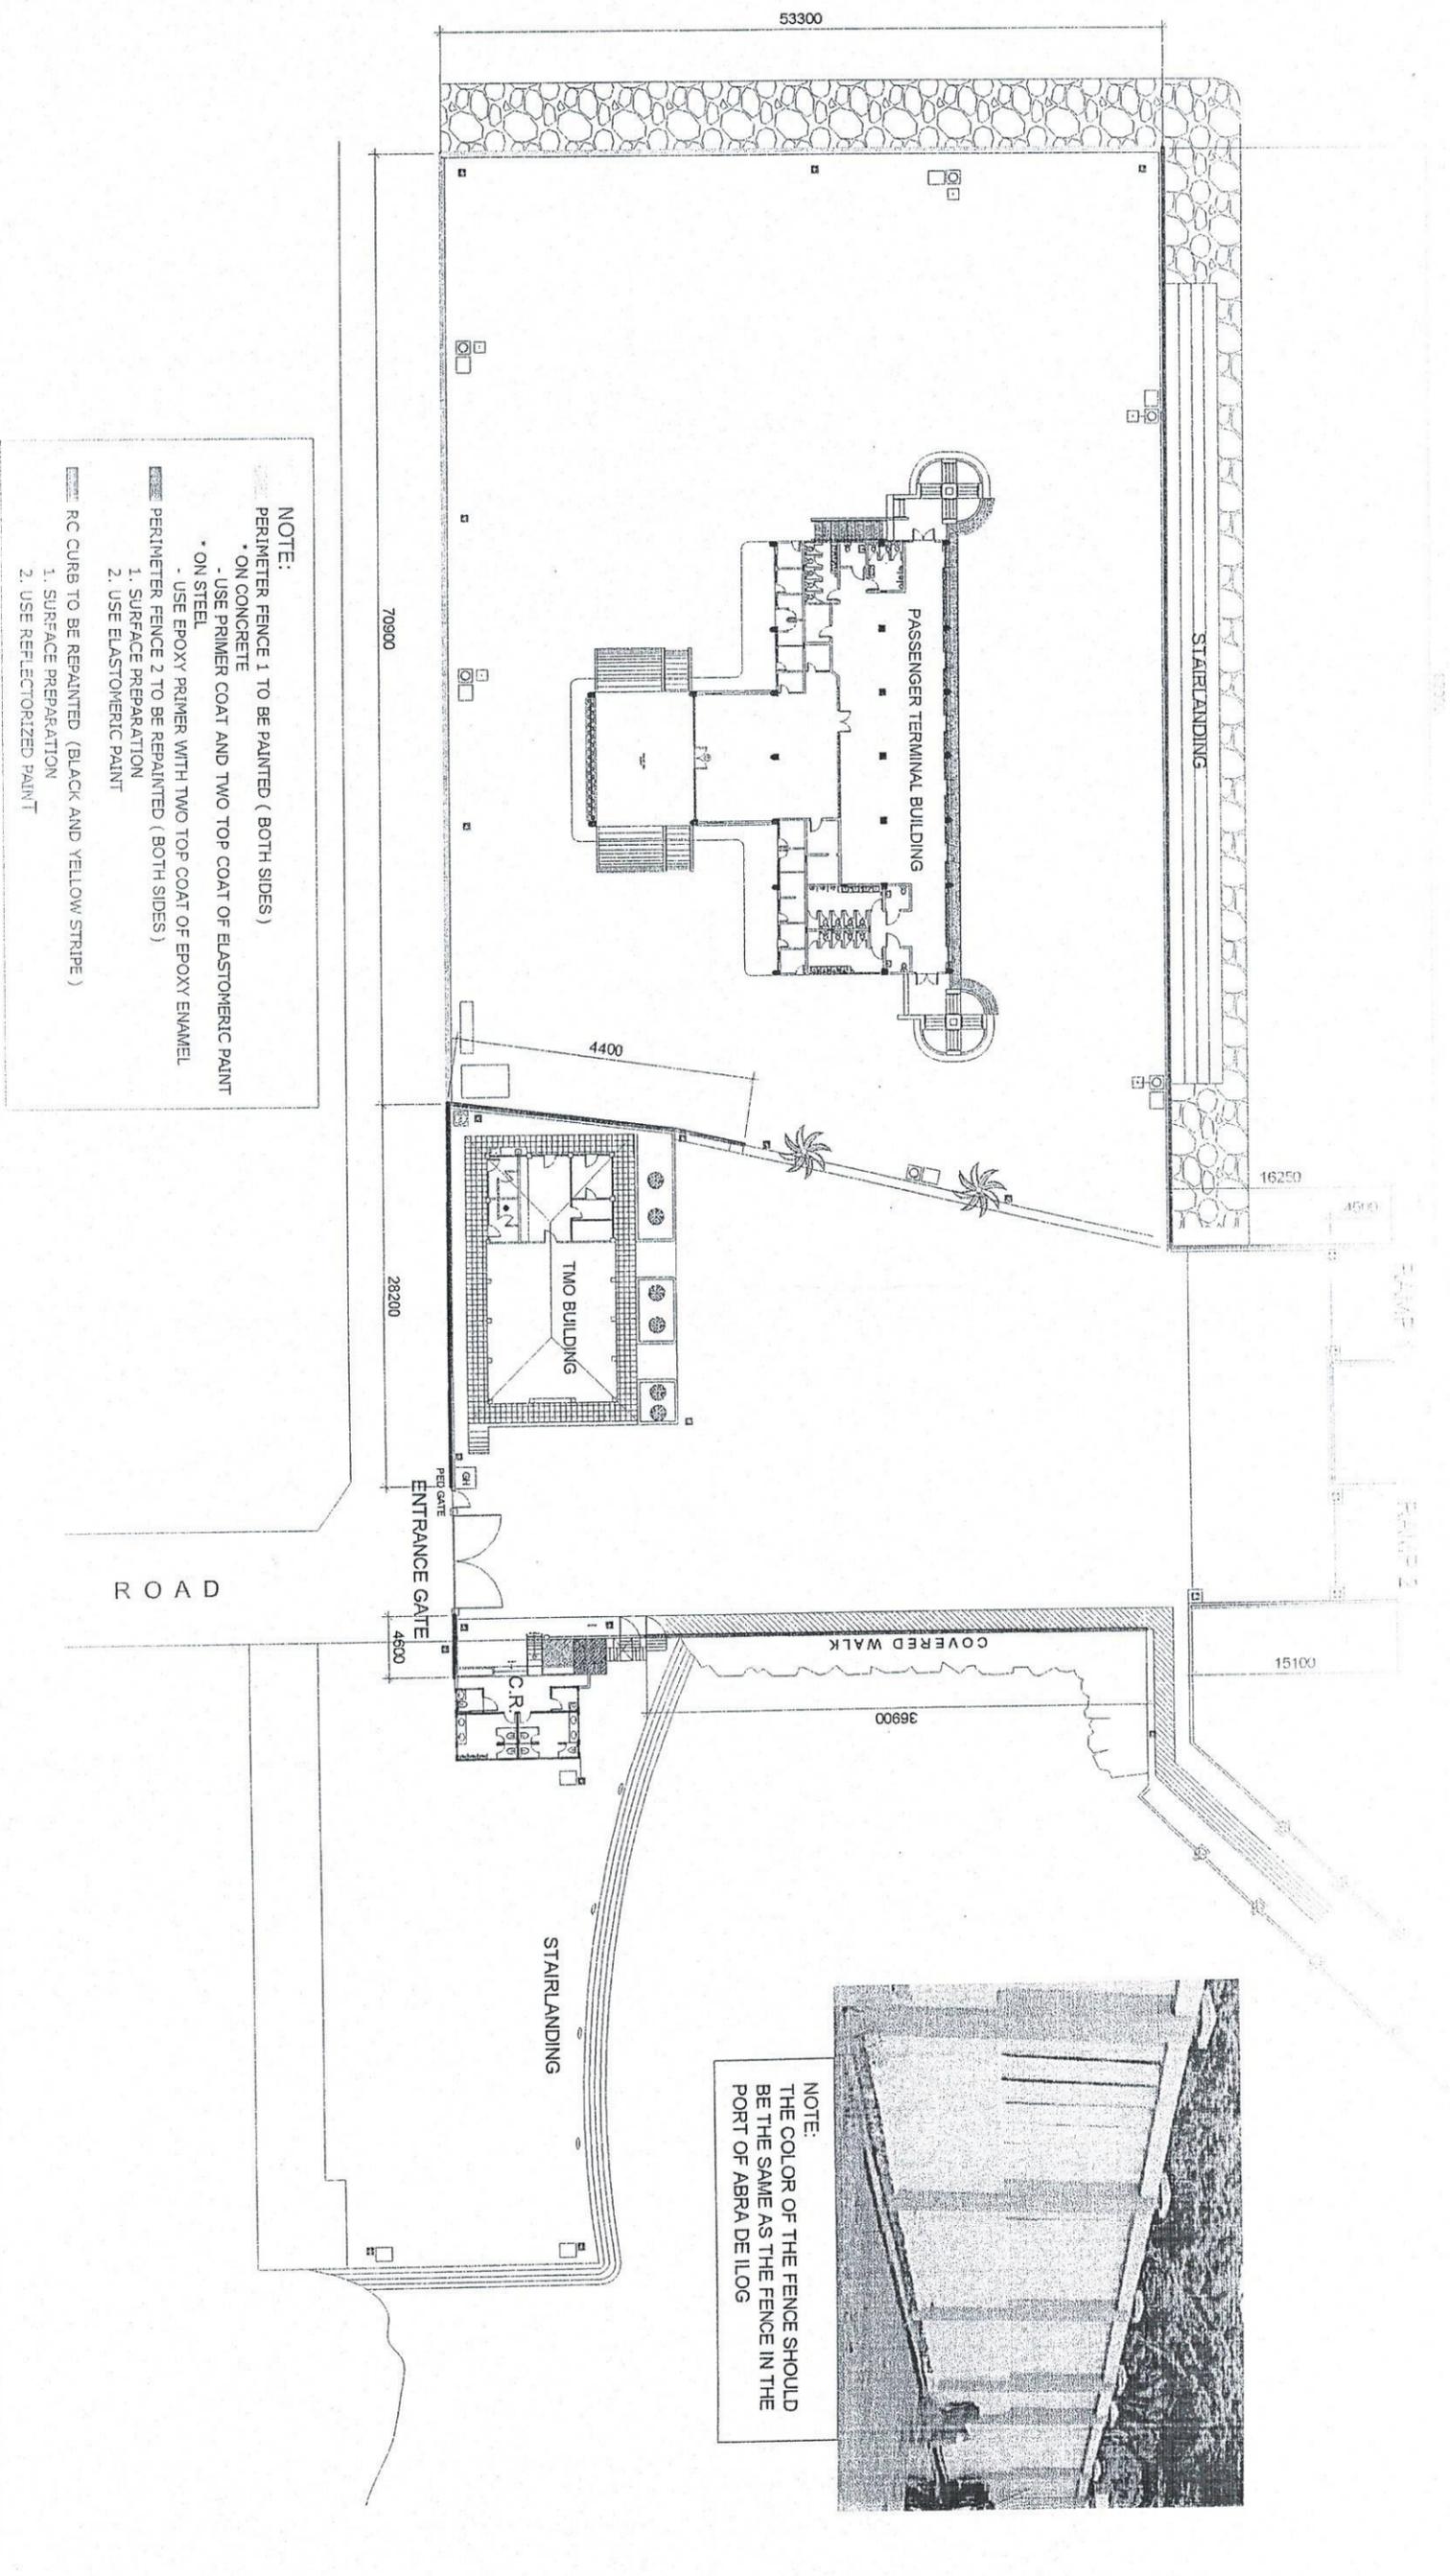

NOTE:
 PERIMETER FENCE 1 TO BE PAINTED (BOTH SIDES)
 * ON CONCRETE
 - USE PRIMER COAT AND TWO TOP COAT OF ELASTOMERIC PAINT
 * ON STEEL
 - USE EPOXY PRIMER WITH TWO TOP COAT OF EPOXY ENAMEL
 PERIMETER FENCE 2 TO BE REPAINTED (BOTH SIDES)
 1. SURFACE PREPARATION
 2. USE ELASTOMERIC PAINT
 RC CURB TO BE REPAINTED (BLACK AND YELLOW STRIPE)
 1. SURFACE PREPARATION
 2. USE REFLECTORIZED PAINT

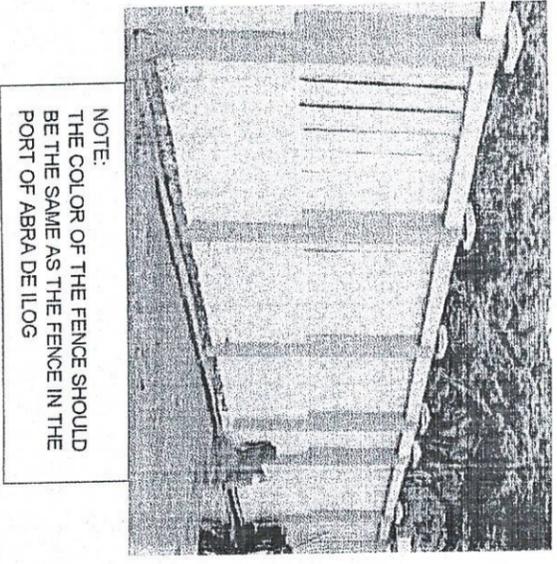

NOTE:
 THE COLOR OF THE FENCE SHOULD BE THE SAME AS THE FENCE IN THE PORT OF ABRA DE ILOG

PROJECT TITLE: VARIOUS REPAINTING WORKS


PORT OF ABRA DE ILOG, ORIENTAL MINDORO

DESIGNED BY D. M. M. M.	DESIGNED BY D. M. M. M.	DESIGNED BY D. M. M. M.	DESIGNED BY D. M. M. M.
PREPARED BY D. M. M. M.	SUBMITTED BY D. M. M. M.	REVISIONS RECEIVED BY D. M. M. M.	REVISIONS RECEIVED BY D. M. M. M.
DATE D. M. M. M.	DATE D. M. M. M.	DATE D. M. M. M.	DATE D. M. M. M.
PROJECT NO. 126/10	SHEET NO. 126/10	DATE 10 FEBRUARY 2003	


SHEET CONTENTS: SCALE AS SHOWN

ANALYSIS SYSTEM: RAJNE
(SEE DETAIL NO.)

SCALE
(SEE SYSTEM)

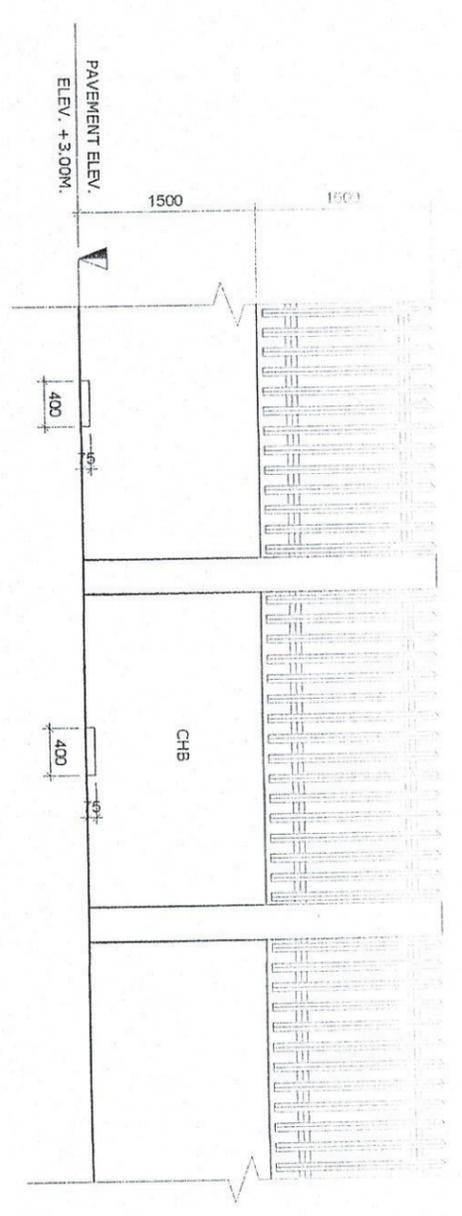


FENCE 1 PLAN ELEVATION
SCALE 1:50 M.

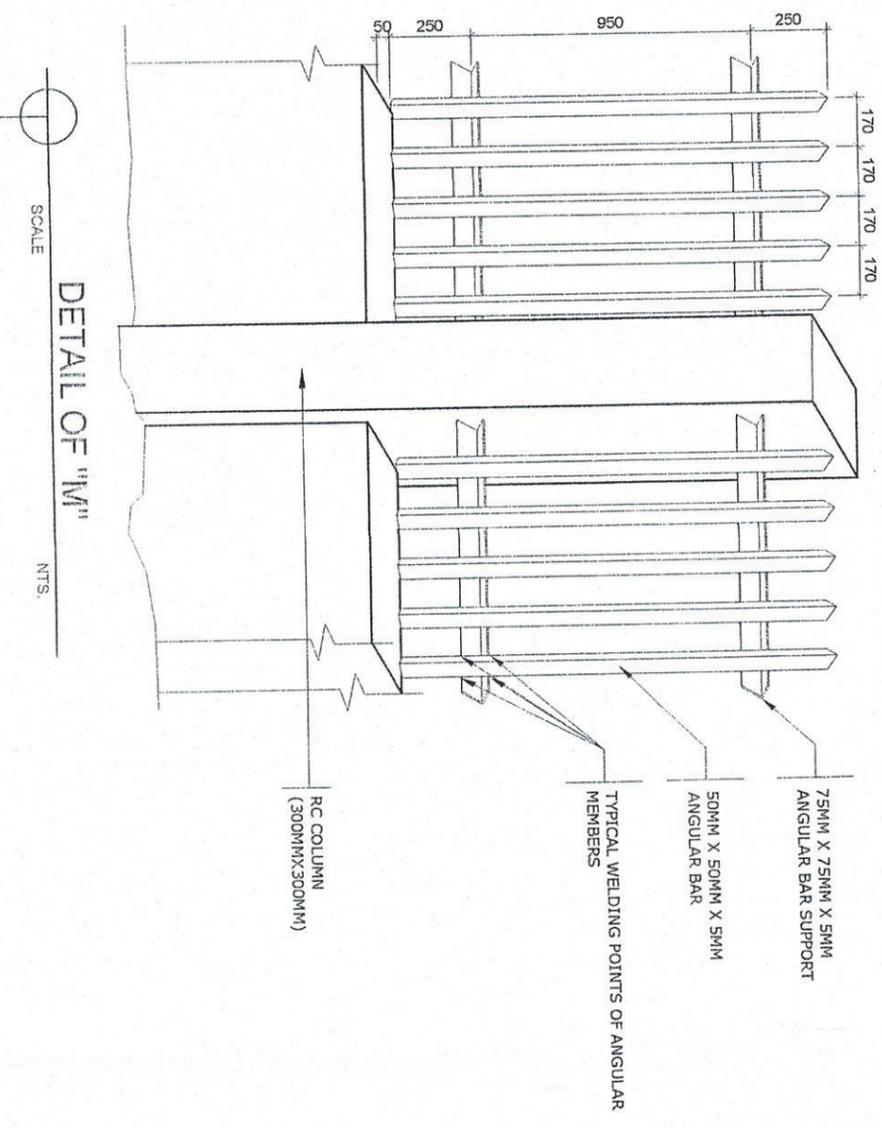

DETAIL OF "M"
SCALE NTS.



FENCE 2 PLAN (PRE-CAST)
SCALE 1:50 M.

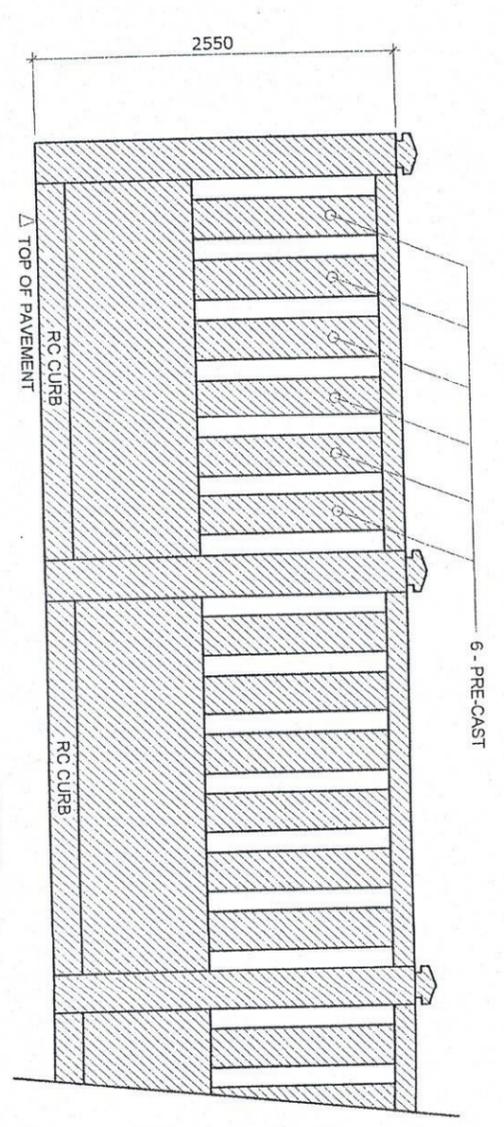

FENCE 2 ELEV. (PRE-CAST)
SCALE 1:50 M.

NOTE:

- PERIMETER FENCE 1 TO BE PAINTED (BOTH SIDES)
- ON CONCRETE
 - USE PRIMER COAT AND TWO TOP COAT OF ELASTOMERIC PAINT
- ON STEEL
 - USE EPOXY PRIMER WITH TWO TOP COAT OF EPOXY ENAMEL
- PERIMETER FENCE 2 TO BE REPAINTED (BOTH SIDES)
 1. SURFACE PREPARATION
 2. USE ELASTOMERIC PAINT
- RC CURB TO BE REPAINTED (BLACK AND YELLOW STRIPE)
 1. SURFACE PREPARATION
 2. USE REFLECTORIZED PAINT

PROJECT TITLE: VARIOUS REPAIRING WORKS

PORT OF PUERTO GALERA, ORIENTAL MINDORO

SHEET CONTENTS: SCALE: AS SHOWN

SHEET NO. 10 of 13

DATE: 10 FEBRUARY, 2023

DESIGNED BY: [Signature]

CHECKED BY: [Signature]

APPROVED BY: [Signature]

RECOMMENDED BY: [Signature]

DATE: [Signature]