



VEHICLE GATE PLUNGER DETAIL  
SCALE: 1/8"=1'-0"





MTS CONNECTION @ GATE

[illegible]

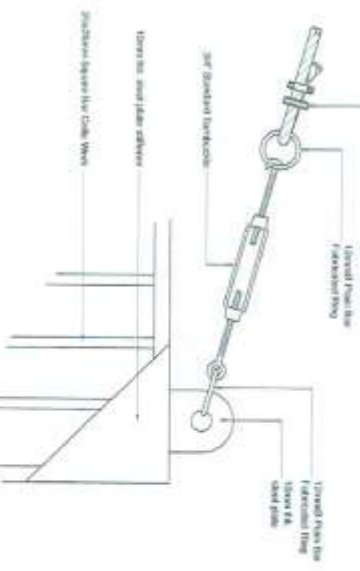

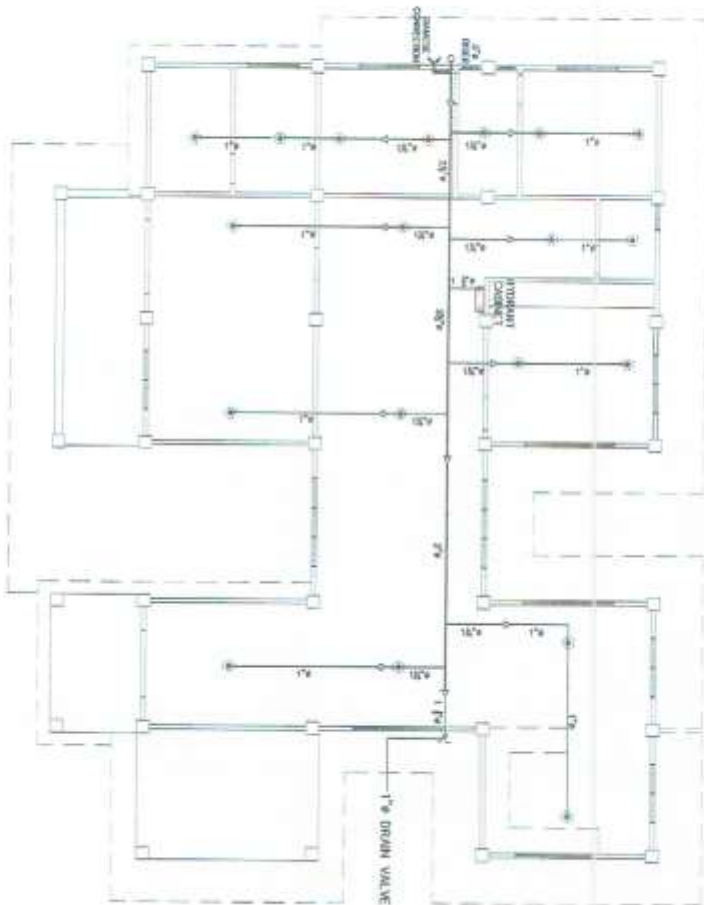

○ FIRE SPRINKLER LAYOUT  
SCALE: 1/8" = 1'-0"

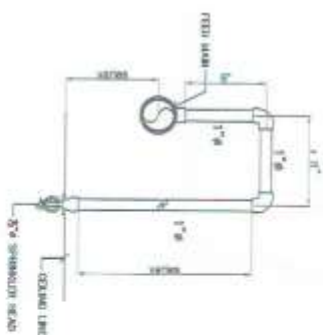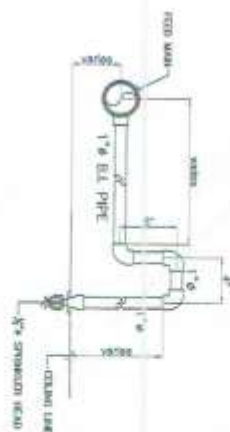


○ TYP. SPRINKLER HEAD DROP LINE  
SCALE: 1/8" = 1'-0"

	PROJECT TITLE: PROJECT: CONTINGUOUS FIRE PROTECTION SYSTEMS LOCATION: PORTLAND, OREGON CLIENT: PORTLAND FIRE DEPARTMENT DATE: 7/2/76	DESIGNED BY: 	CHECKED BY: 	APPROVED BY: 	PROJECT NO.: 72176	DATE: 7/2/76	DRAWN BY: 72176
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	PROJECT: CONSTRUCTION OF TANKER LARK, COVERED COURT, TANK IDENTIFY, AND REMEDIAL SYSTEM AT PORT OPERATIONS BUILDING PORT OF GENERAL SANTOS, MARINA BRANCH GENERAL SANTOS CITY							DATE: 7/3/76
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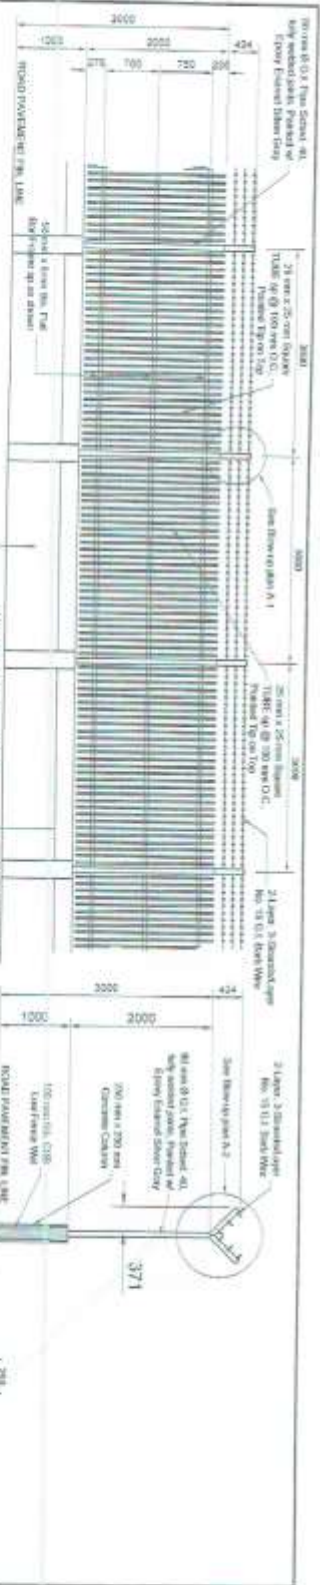
**FIRE SPRINKLER ISOMETRIC**  
 1/2" TO SCALE



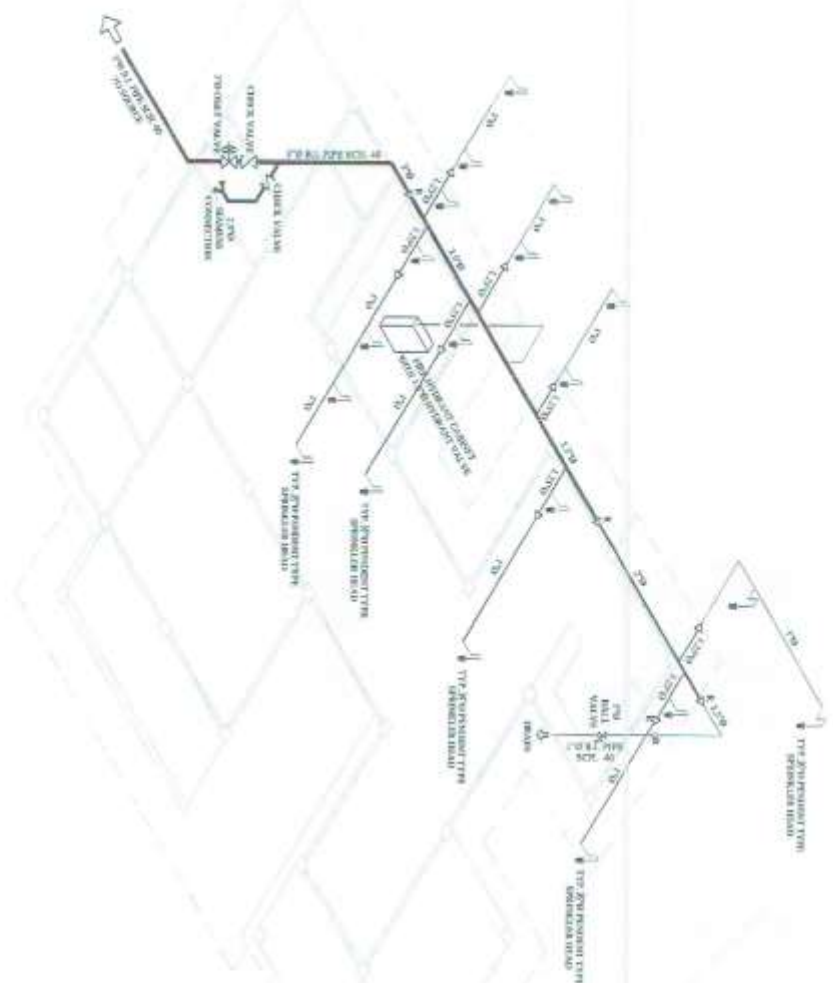


## MATH. PHYSICS STUDY - 20






**PART ELEVATION OF CYCLONE WIRE FENCE (TYPICAL)**  
SCALE: 1:50 (AS SHOWN)

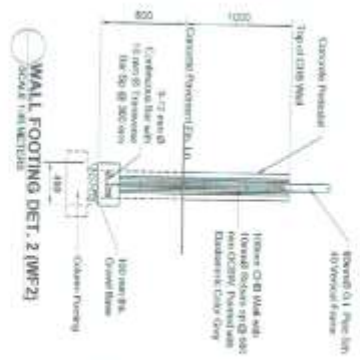

**WALL FOOTING DET. 2 (WF-2)**  
SCALE: 1:50 (AS SHOWN)

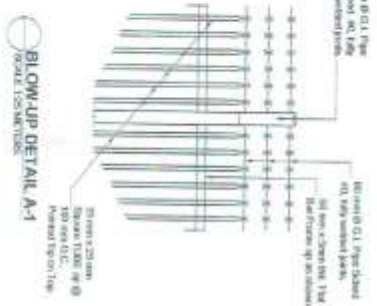


**BLOW-UP DETAIL A-1**  
SCALE: 1:50 (AS SHOWN)

**BLOW-UP DETAIL A-2**  
SCALE: 1:50 (AS SHOWN)


**OPERATIONAL FENCE DETAIL**  
SCALE: 1:50 (AS SHOWN)

**COLUMN FOOTING DETAIL-CF6**  
SCALE: 1:50 (AS SHOWN)

	<p>PROJECT: <b>PROPOSED CONSTRUCTION OF FLOODING AREA, GARDEN OF EASE, WATER, AND DRAINAGE SYSTEM AT PORT GARDEN, CAPE TOWN</b></p>	<p>CLIENT: <b>CITY OF CAPE TOWN, WATER AND SANITATION DEPARTMENT</b></p>	<p>DESIGNER: <b>ARCHITECTS &amp; ENGINEERS (Pty) Ltd</b></p>	<p>REVIEWER: <b>ARCHITECTS &amp; ENGINEERS (Pty) Ltd</b></p>	<p>APPROVED: <b>ARCHITECTS &amp; ENGINEERS (Pty) Ltd</b></p>	<p>DATE: <b>7/5/76</b></p>
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SEPTIC VAULT DETAIL (PM's QUARTER)  
DATE: 11/15/13

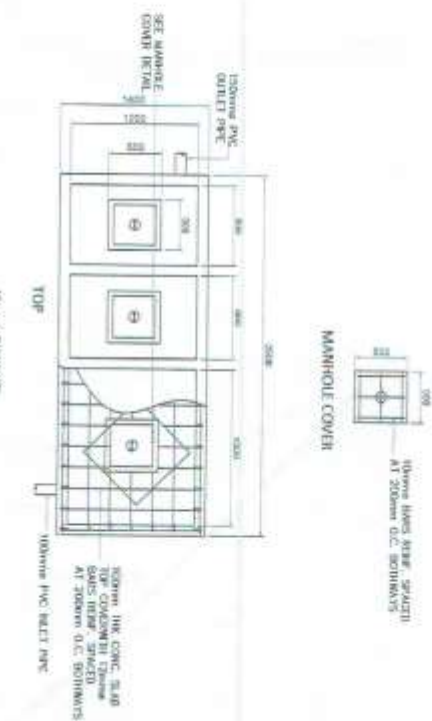

SEPTIC VAULT DETAIL (COVERED COURT)  
SCALE 3/4"

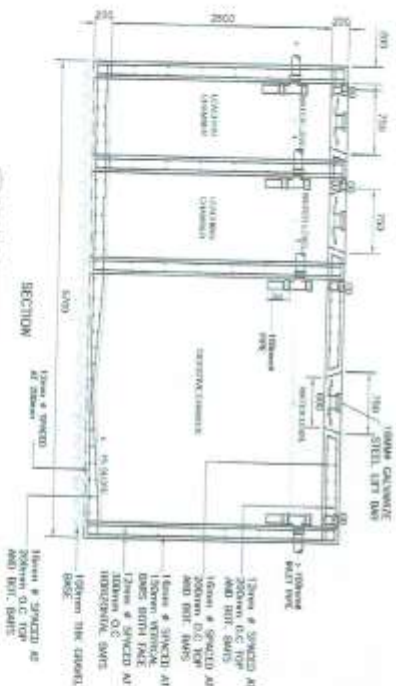