

- e) All excavations fill and backfill and concrete works involved herein, shall be carried to the required elevations and shall conform to the provisions of specification under Earthwork and Concrete Construction of this tender document.
- f) The materials and equipment to be furnished shall be standard products of reputable manufacturer engaged in the reproduction of such materials and equipment.
- g) All permits and electrical fees required for this work shall be obtained at the expense of the Contractor. The Contractor shall furnish the Engineer-in-Charge, the final Certificates of Inspections and approval from the proper government authorities after the completion of work. The Contractor shall prepare all as- built plans and all other paper works as required by the enforcing authorities.
- h) The Contractor shall furnish and install electrical materials as shown in the drawings. A licensed Electrical Engineer or Master Electrician is required to implement the installation of the electrical system.
- i) Electrical installation shall conform to the requirements of Philippine Electrical Code (PEC) and the other approved standards.
- j) The contractor shall install all electrical works with the supervision of the qualified Registered Electrical Engineer (REE) or Master Electrician. All electrical installation applications regardless of capacity and voltage whether new, addition or revision shall be accompanied by electrical plans signed and sealed by a duly licensed Professional Electrical Engineer (PEE).

MATERIAL REQUIREMENTS

All materials shall be brand new and shall be of the approved type meeting all the requirements of the Philippine Electrical Code and bearing the Philippine Standard Agency (PSA) mark.

PRODUCTS

WIRES AND CABLES

The conductor material to be furnished and installed shall be copper wire Heat-Resistant Thermoplastic (THHN/THWN-2). All conductors shall be rated 600 volts insulation and shall be standard for all sizes.

CONDUIT AND FITTINGS

Underground PVC conduit shall be polyvinyl chloride with concrete covered. It shall be manufactured to schedule 40 outside diameter. All fittings and bends shall be solvent bonded using manufacturers recommended product.

INTEGRATED SOLAR-POWERED LIGHTING ASSEMBLY

Specifications:

Rated	: 120W LED Lamp
Luminous Flux	: 12,000 – 13,000 lumens
Color Temperature	: 2700K - 6500K / Warm White, Nature White, Daylight
Input Voltage	: AC 90-305V / 50-60 HZ
Light Source	: High Brightness SMD LED
Material	: Aluminum Housing + Acrylic Cover
Beam Angle	: 140 degrees

Lifetime : > 50,000 hours
IP Rating : IP 65 outdoor (Water Resistant)

CONCRETE DUCT BANK

The contractor shall construct concrete duct bank as shown in the approved plan.

INTEGRATED SOLAR-POWERED PORT LIGHTS (6.10 meter height)

The Integrated Solar-Powered Port Lights shall be transported by the contractor to the erection sites at his expenses and responsibility and shall be handled with care to avoid bending or damaged to the galvanizing. Materials on which galvanizing has been damage shall be re-dipped unless in the opinion of the Engineer the damage is local and can be repaired by painting with at least two (2) coats of zinc paint. The repair shall be made by and at the expense of the contractor. The number of floodlight fixtures pre required as shown in the plan.

Detail connection of Integrated Solar-Powered Port Lights as shown in the plan. Anchor bolts to be stainless steel or galvanized steel and designed and provided by the Integrated Solar-Powered Port Lights manufacturer to ensure that the Integrated Solar-Powered Port Lights and anchor bolts assembly capacity meets all the stresses composed of wind, luminaires weight and live load of maintenance personnel.

PROTECTIVE COATING FOR INTEGRATED SOLAR-POWERED PORT LIGHTS

Hot Dipped Galvanizing Preparation

All mild steel parts exposed to weather shall be hot-dipped galvanized after fabrication as shown in the approved plan or directed by the Engineer in accordance with the requirements if JIS H88641. Prior to galvanizing, the surface shall be cleaned of dirt, weld splatter, grease, slag, oil, paint or other deleterious matters. The steel surfaces shall be chemically descaled and cleaned with abrasive blast or other suitable method as approved by the Engineer.

Coating

The zinc coating shall consist of uniform layer of commercially pure zinc free from abrasions, cracks, blisters, chemical spots or other imperfections, and shall adhere firmly to the surface of the steel. The weight of the zinc coating per square meter of actual surface shall not be less than 550 grams. Any surface damaged subsequent to galvanizing shall be given two coats of approved zinc paint.

Painting of Galvanize Steel Work

Hot-dipped galvanized high mast tower are to be treated at the works with an appropriate zinc chromate two packs etch primer followed by one coat of non-etch zinc chromate primer and one coat of micaceous iron oxide paint before shipment. On site damage to the coating is to be repaired and a final coat of micaceous iron oxide is to be applied after erection, generally in accordance with the specifications for shot blasted steel.

WARRANTY

Manufacturer must submit a warranty for the corrosion resistant cladding material against manufacturing defects for a period of one (1) year from the date of original purchase.

LIGHTNING PROTECTION WITH ACCESSORIES

It consists of air terminals, down conductors, ground connections, grounding electrodes as shown in the plan.

PANEL BOARD / Distribution Panel Board

Panel board shall conform as shown on the approved plans with respect to supply characteristics, rating of main lugs or main circuit breaker, number and ratings and capacities of branch circuit breakers.

Panel board shall consist of a factory completed dead front assembly mounted in an enclosing NEMA-3R cabinet consisting of code gauge galvanized sheet steel box with trim and door.

Main and branch circuit breakers for panel board shall have the rating, capacity and number of poles as shown on the approved plans. Breakers shall be thermal magnetic type solid state-type with interrupting capacity of 10,000 amperes symmetrical minimum. Breaker terminal shall be UL listed as suitable for type of conductor provided. Breaker shall be the bolt-in type (that is, bolted to the current carrying bus). Plug-in circuit breakers are not acceptable

EXECUTION

INSTALLATION

The contractor shall use standard and accepted practice and methods of erecting the high mast tower depending upon their location. The high mast tower shall be erected by the contractor in accordance with the structure list and the erection diagrams prepared by the high mast tower manufacturer.

The high mast tower may be erected by assembling in sections on the ground and hoisting successive sections in place, or they may be build-up in place individual members at the option of the contractor. If erected by assembling in sections, not less than fifty percent (50%) of all bolting in place shall be done on each section before starting another section. All bolts shall be drawn up tight but not to such a degree as to endanger the strength of the bolt. All nuts shall be locked in place. All bolts ends below three (3) meters above ground should be flattened to prevent the nut from being taken out from the bolt. Only wrenches approved by the Engineer shall be used on the work, and the use of any wrench that may deform the nut or cut or flake the galvanizing shall not be permitted.

A reasonable amount of drifting shall be allowed in assembling but reaming for correction of mismatched holes due to shop errors shall be permitted. If any shop error in the steel is discovered, the contractor shall notify the Engineer, who will decide whether the errors may be corrected in the field or the members returned to the manufacturer for correction or replacement. Galvanized damaged during the corrections of shop errors shall be repaired in accordance with the plans/ specifications.

Final inspection of the high mast tower shall be made by the Engineer who shall make and report all loose bolts and other errors in erection, and shall make sure all bolts are in place and are tightened properly and that all nuts are locked properly.

The high mast tower shall be erected so that any portion of the high mast tower shall be in correct position relative to the high mast tower vertical center line, which shall not deviate from any plumb by more than 0.2% of height in either the transverse or longitudinal direction.

Construction of reinforced concrete high mast tower foundation and ductbank shall be in accordance with all the details in the plan.

Excavations / backfilling required before /after installation of high mast tower and concrete pedestal post shall conform to the provisions of Earthwork and Concrete Construction.

Concrete Pedestal Post shall be reinforced concrete with appropriate weatherproof fittings as constructed as shown in the approved plan. Reinforced concrete materials shall conform to the requirements of concrete. Concrete shall be of 210kg/cm² compressive strength.

Metering: the local utility company of Port of Cagayan de Oro, Cagayan de Oro, Misamis Oriental, is responsible for the supply and installation of measuring equipment, and its accessories, but it is part of the contractor responsibility and expense to contact them about this.

WORKMANSHIP

The work throughout shall be executed in the best and most thorough manner under the direction of and at the satisfaction of the Registered Electrical Engineer or Master Electrician, who will interpret the intent meaning of the drawings and specification and shall have the power to reject any work and materials which in his judgment, are not in full accordance therewith.

TESTING OPERATIONS

When the electrical installation is completed, the Contractor shall test the installed electrical materials and equipment in the presence of Registered Electrical Engineer or Master Electrician. The system shall be free from any defects, shorts or grounds. The Contractor at no extra cost shall furnish all necessary instruments and personnel required for the testing.

GUARANTEE

Upon completion and before final acceptance of the work, the Contractor shall furnish the Engineer a written guarantee stating that all works executed are free from defects on materials and workmanship. The guarantee shall be for a period of one year from the date of the final acceptance. Any work that becomes defective during the said period shall be corrected / replaced by the Contractor at his own expense in a manner satisfactory to the Authority.

ITEM 7 : PROJECT BILLBOARD**SPECIFICATION**

The Project Billboard shall be installed at location(s) designated by the Engineer.

The size and specifications of materials for the standard billboard shall be 4ft. x 8ft. (1,200mm x 2,400mm) using ½ inch (12mm) marine plywood or tarpaulin poster on 3/16 inch (5mm) marine plywood.

Project billboards shall not contain Name(s) and/or picture(s) of any personages.

See attached drawings for further details of the standard billboard.

2438 (8 ft.)

(Name of Project and Location)

CONTRACTOR
EFFECTIVITY OF CONTRACT
CONTRACT COMPLETION DATE
CONTRACT COST
IMPLEMENTING OFFICE
SOURCE OF FUND

PHILIPPINE
PORTS
AUTHORITY


37mm YELLOW BORDER LINE


WHITE BACKGROUND

ARIAL BLACK TEXT

ARIAL DARK BLUE TEXT

STANDARD PROJECT BILLBOARD

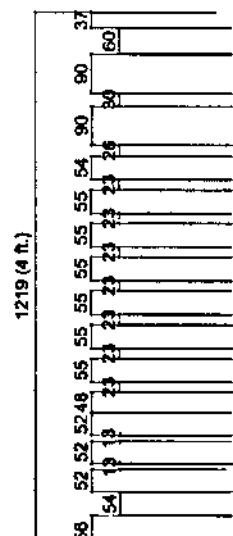

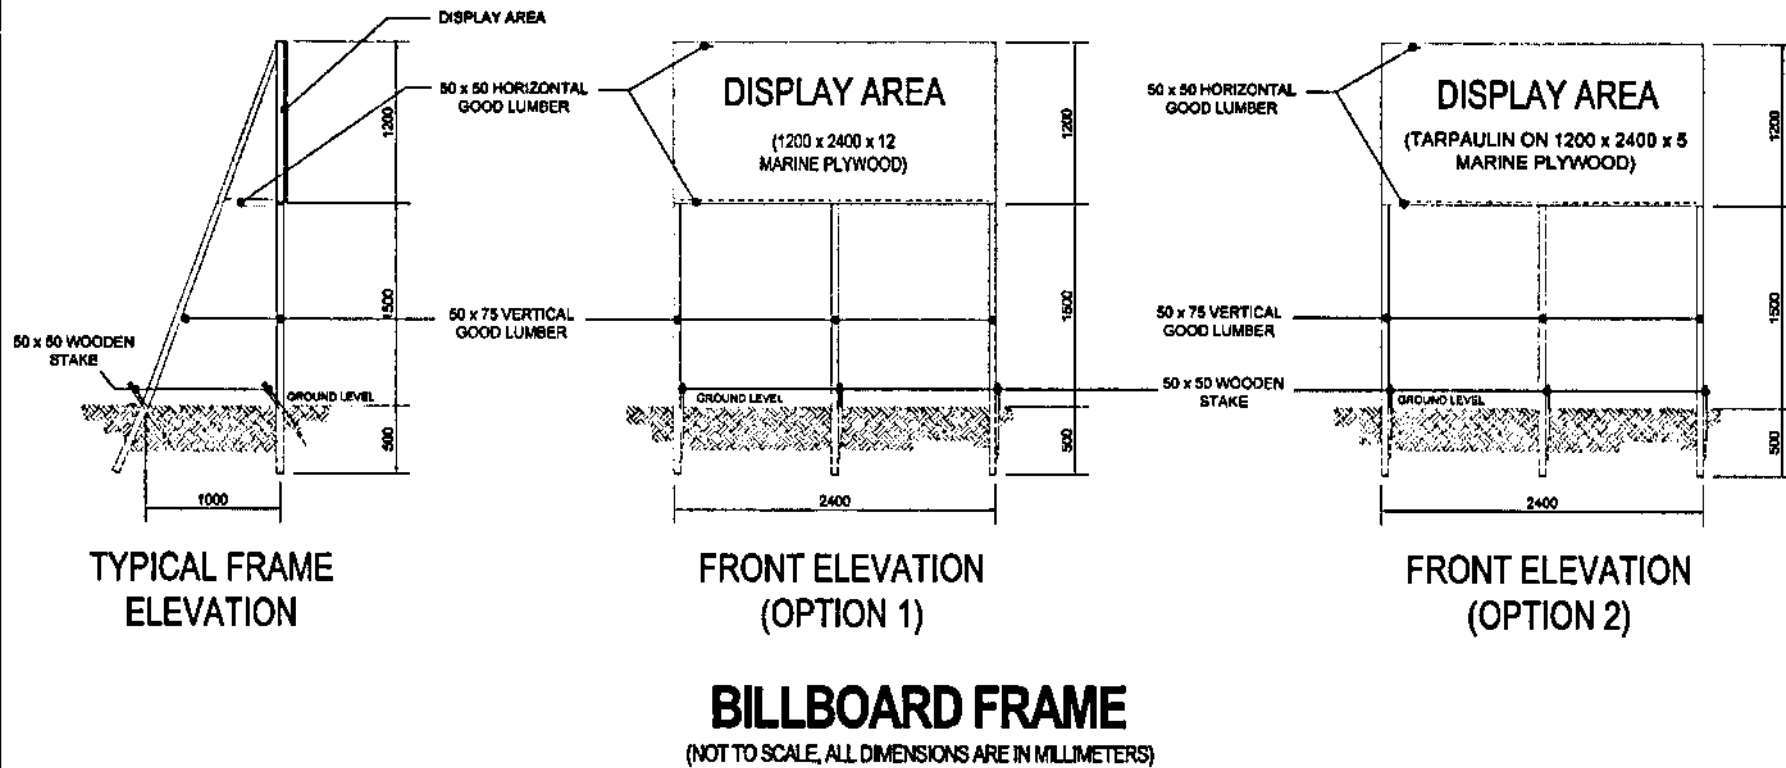

ITEM 8 : SAFETY SIGNAGES AND BARRICADES

DESCRIPTION

This work includes the furnishing and installing of safety signages and barricades in accordance with the specifications and to the details shown below in the drawings, or as directed by the Engineer.


SPECIFICATION

The Signage's and Barricades shall be installed at location(s) designated by the Engineer.

The sizes of the standard signages shall be 2-2/3ft x 4ft (800mm X 1,200mm) for fixed type and 2ft x 2-2/3ft (600mm x 800mm) for mobile type. For barricade standard 2ft x 2-2/3ft (600mm x 800mm) shall be provided.

The materials to be used for signages and barricades are ½ inch (12mm) marine plywood or tarpaulin poster on 2" x 2" (50mm x 50mm) good lumber frame (see drawing below).

The printing or painting shall be the discretion of the Engineer.

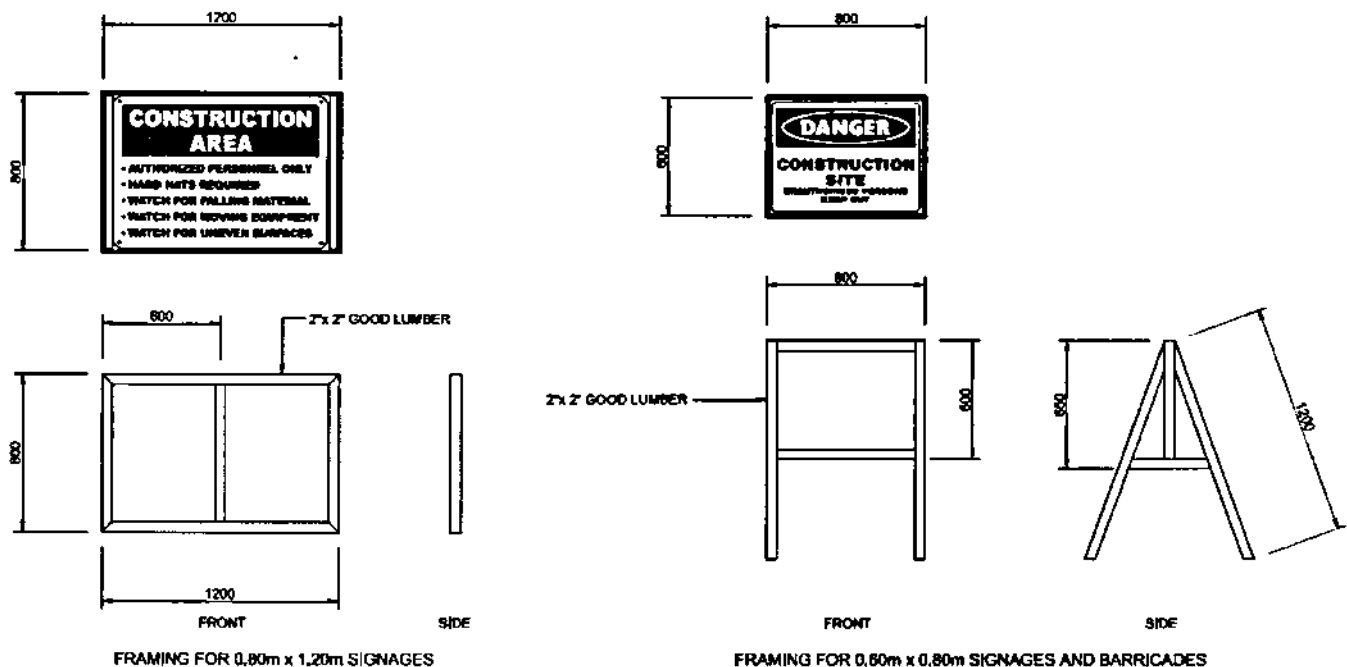

STANDARD PLAN FOR SIGNAGES AND BARRICADES

SECTION VII

*DRAWINGS
(APPROVED PLANS)*

SECTION VII

DRAWINGS AND APPROVED PLANS

(SEE ISSUED APPROVED PLANS)

LIST OF DRAWINGS:

- 1 of 14 - Development Plan
- 2 of 14 - General Plan
- 3 of 14 - Pavement Joint Lay-Out Plan, Pavement Section, Typical Pavement Joints
- 4 of 14 - Foundation Lay-Out Plan, Section Thru – “A”, Section Thru – “B”
- 5 of 14 - Elevation, Section, Arrangement of Landscaping Trees & Plants Detail of Segregation Island
- 6 of 14 - Drainage Lay-out Plan
- 7 of 14 - Section Thru – “C”, Detail of Sidewalk & Gutter, Paint Detail of R.C. Curb
- 8 of 14 - Top View of Drainage Intake and Manhole, Detail of Drainage Intake and Manhole, Detail of Steel Grating, Detail of Manhole Cover
- 9 of 14 - Floor Plan, Front Elevation, Rear Elevation, Left & Right Elevation, Section Thru - “X”, Schedule of Doors and Windows
- 10 of 14 - Roof Framing Plan, Roof Plan, Electrical lay-out Plan, Schedule of Load
- 11 of 14 - Roof Slab & Beam Detail, Foundation Plan, Wall & WF1 Detail, C1/F1 Detail
- 12 of 14 - Location Plan, Detail of Handhole, Detail of Concrete Duct Encasement
- 13 of 14 - Port Lighting Location Plan
- 14 of 14 - Detail of Integrated Solar-Powered Port Lights (Single), Specifications, Detail of Pedestal Post, Base Plate Detail

**PHILIPPINE
PORTS
AUTHORITY**




PORT MANAGEMENT OFFICE - MARINDUQUE/QUEZON

CONSTRUCTION DRAWINGS


PROVISION OF LAY-BY AREA FOR WEIGH-BRIDGE

PORT OF LUCENA

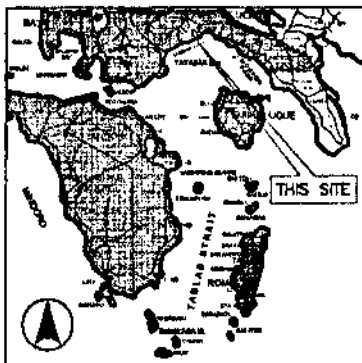



LUCENA CITY




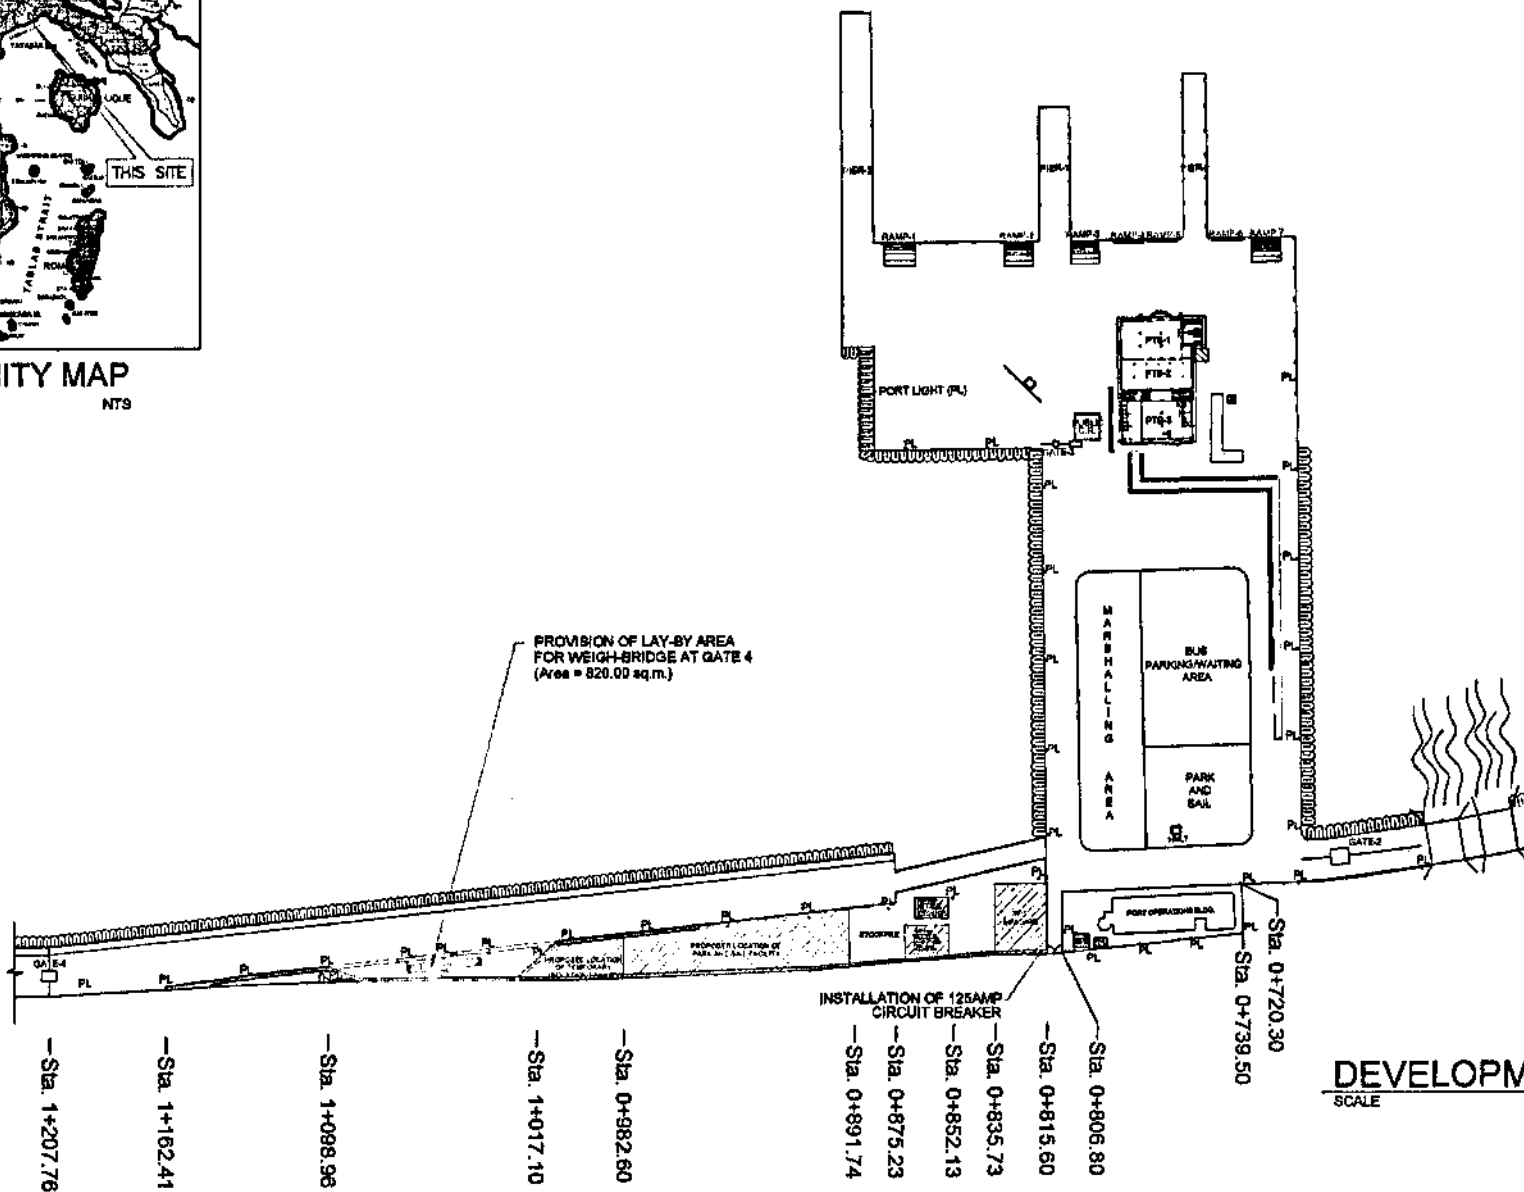



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SCALE NTS




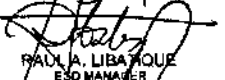

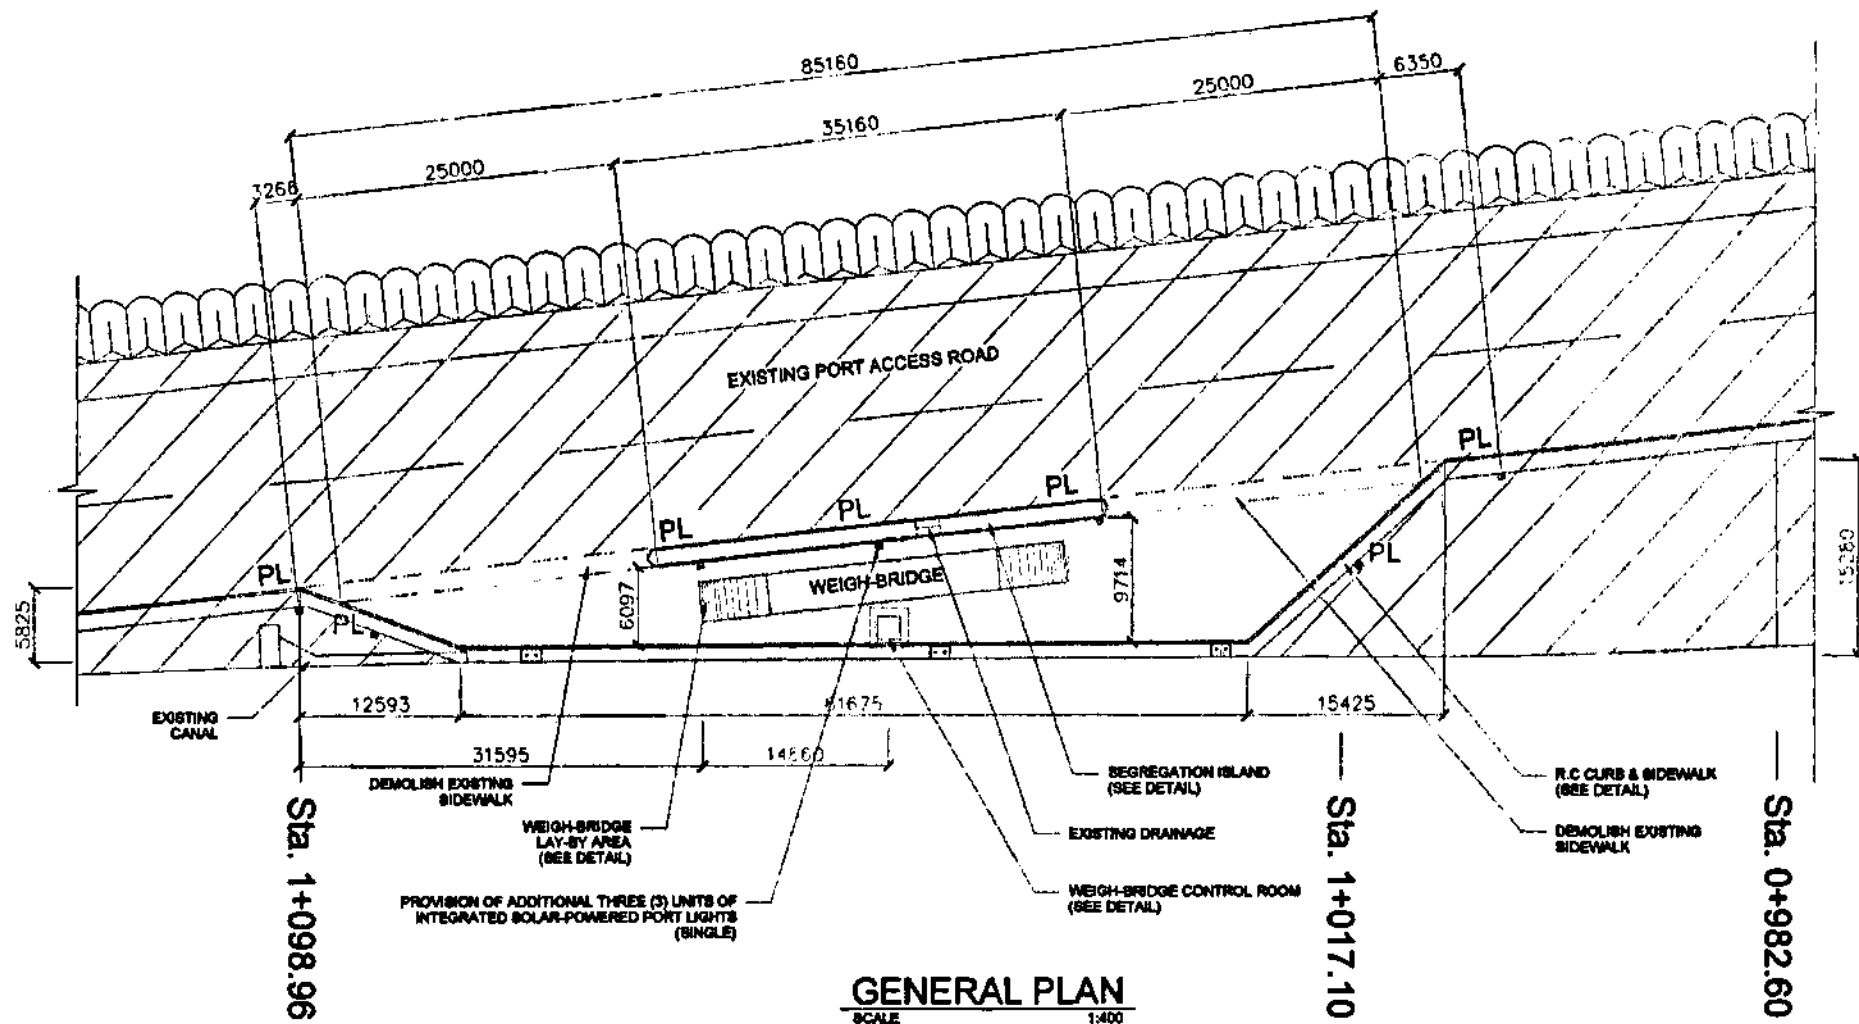

DEVELOPMENT PLAN
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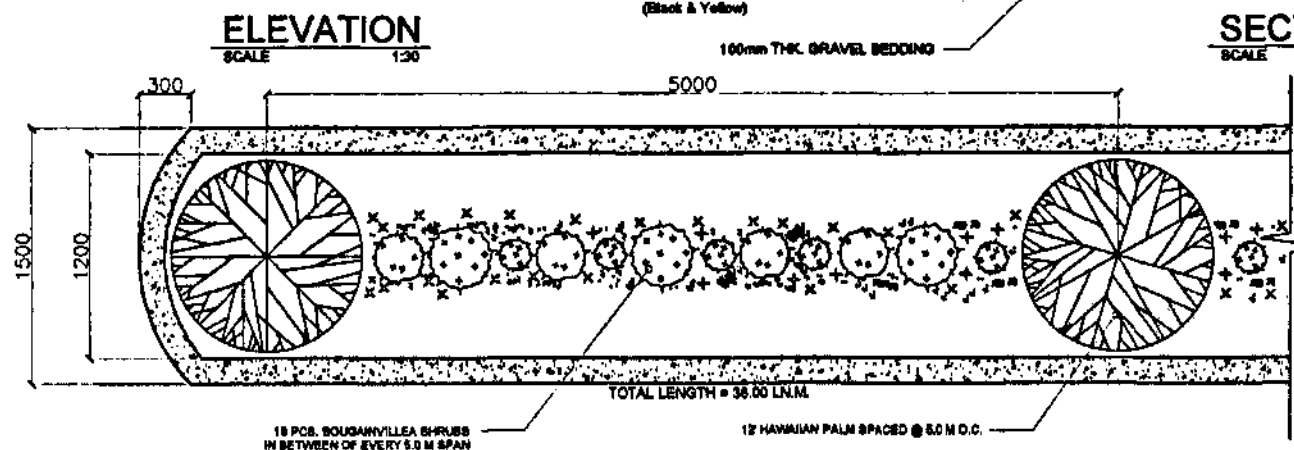
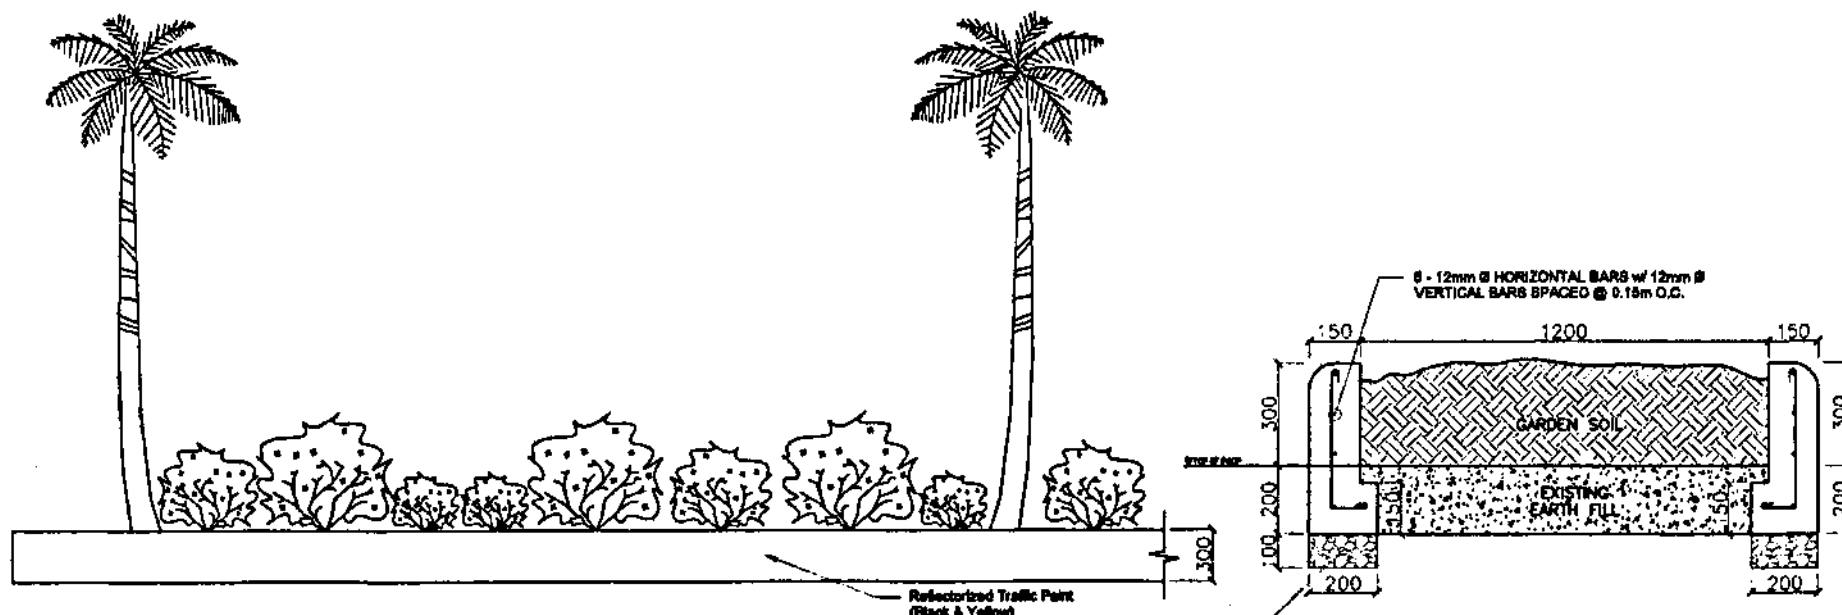
 PHILIPPINE PORTS AUTHORITY PORT MANAGEMENT OFFICE - MARQUEZ	PROJECT LOCATION: PROVISION OF LAY-BY AREA FOR WEIGH-BRIDGE PORT OF LUCENA LUCENA CITY	PREPARED BY:  MARK ANDREW S. BINEDA ACTING SUPERVISING ENGINEER A	REVIEWED/RECOMMENDING APPROVAL:  PAUL A. LIBATIQUE ESD MANAGER	APPROVED:  AURORA A. MENDOZA PORT MANAGER	SHEET CONTENTS • DEVELOPMENT PLAN	SHEET NO. 1/14
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 PHILIPPINE PORTS AUTHORITY PORT MANAGEMENT OFFICE - MARQUEZ	PROJECT LOCATION: PROVISION OF LAY-BY AREA FOR WEIGH-BRIDGE PORT OF LUCENA	PREPARED BY:  MARK ANDREWS S. PINEDA ASSISTANT SUPERVISING ENGINEER A	REVIEWED/RECOMMENDING APPROVAL:  RAUL A. LIBSTONE TSD MANAGER	APPROVED:  AURORA A. MENDOZA ACTING PORT MANAGER	SHEET CONTENTS: • GENERAL PLAN	SHEET NO. 2/14
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 PHILIPPINE PORTS AUTHORITY PORT MANAGEMENT OFFICE - MARQUEZ	PROJECT/LOCATION: PROVISION OF LAY-BY AREA FOR WEIGH-BRIDGE PORT OF LUCENA	PREPARED BY:  MARK ANDREW S. PINEDA ACTING SUPERVISING ENGINEER A	REVIEWED/RECOMMENDING APPROVAL:  RAUL A. LIBATIQUE ESD MANAGER	APPROVED:  AURORA A. MENDOZA ACTING PORT MANAGER	SHEET CONTENTS: • PAVEMENT JOINT LAY-OUT PLAN • PAVEMENT SECTION • TYPICAL PAVEMENT JOINTS	SHEET NO. 3/14
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ARRANGEMENT OF LANDSCAPING TREES & PLANTS
SCALE 1:30



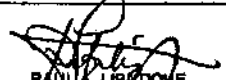

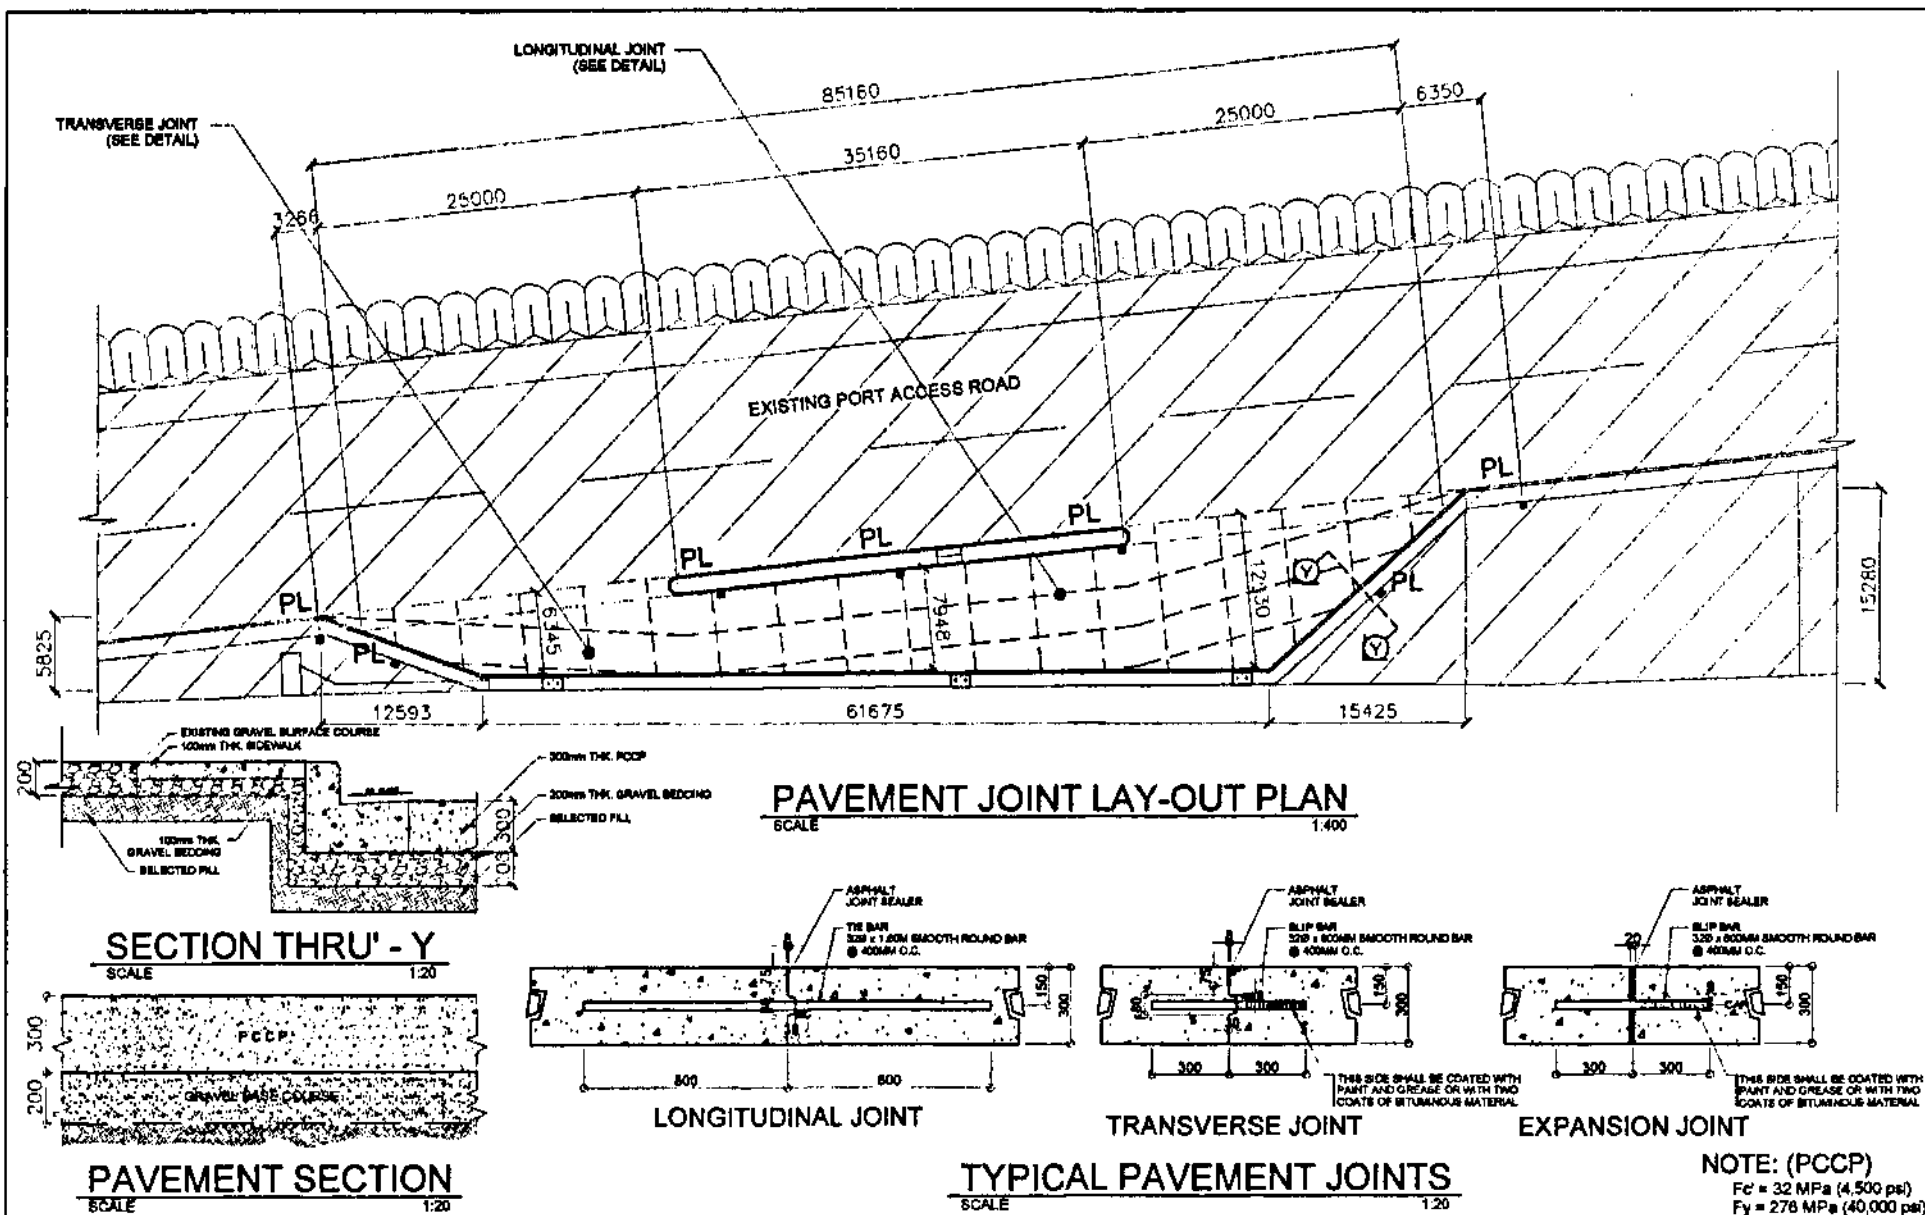DETAIL OF SEGREGATION ISLAND


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
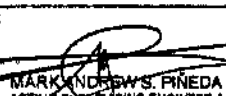
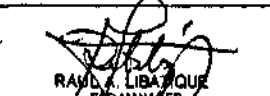

FOR PCPP, SIDEWALK & GUTTER
F_c = 32 MPa (4,500 psi)
F_y = 276 MPa (40,000 psi)

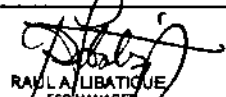
FOR SEGREGATION ISLAND
F_c = 32 MPa (4,500 psi)
F_y = 276 MPa (40,000 psi)

FOR WEIGH-BRIDGE CONTROL ROOM
F_c = 24 MPa (3,500 psi)
F_y = 276 MPa (40,000 psi)


 PHILIPPINE PORTS AUTHORITY PORT MANAGEMENT OFFICE - MARQUEZ	PROJECT LOCATION: PROVISION OF LAY-BY AREA FOR WEIGH-BRIDGE PORT OF LUCENA LUCENA CITY	PREPARED BY:  MARK ANDREW S. PINEDA ACTING SUPERVISING ENGINEER A	REVIEWED/RECOMMENDING APPROVAL:  RAY A. LIBATIQUE EBD MANAGER	APPROVED:  AURORA A. MENDOZA ACTING PORT MANAGER	SHEET CONTENTS: • ELEVATION • SECTION • ARRANGEMENT OF LANDSCAPING TREES & PLANTS	SHEET NO. 5/14
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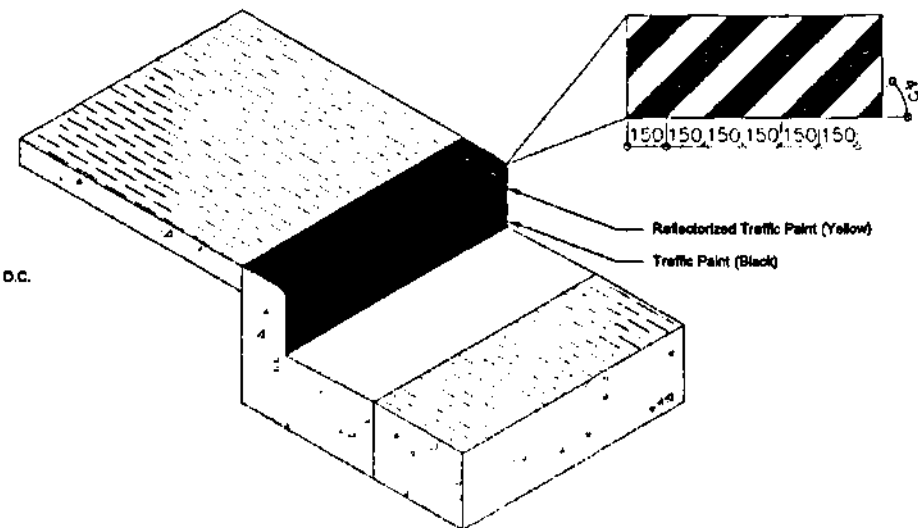
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



SECTION THRU' - C
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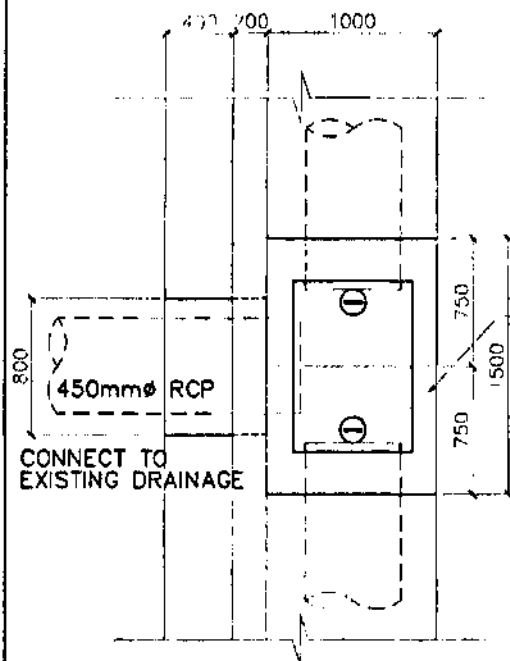


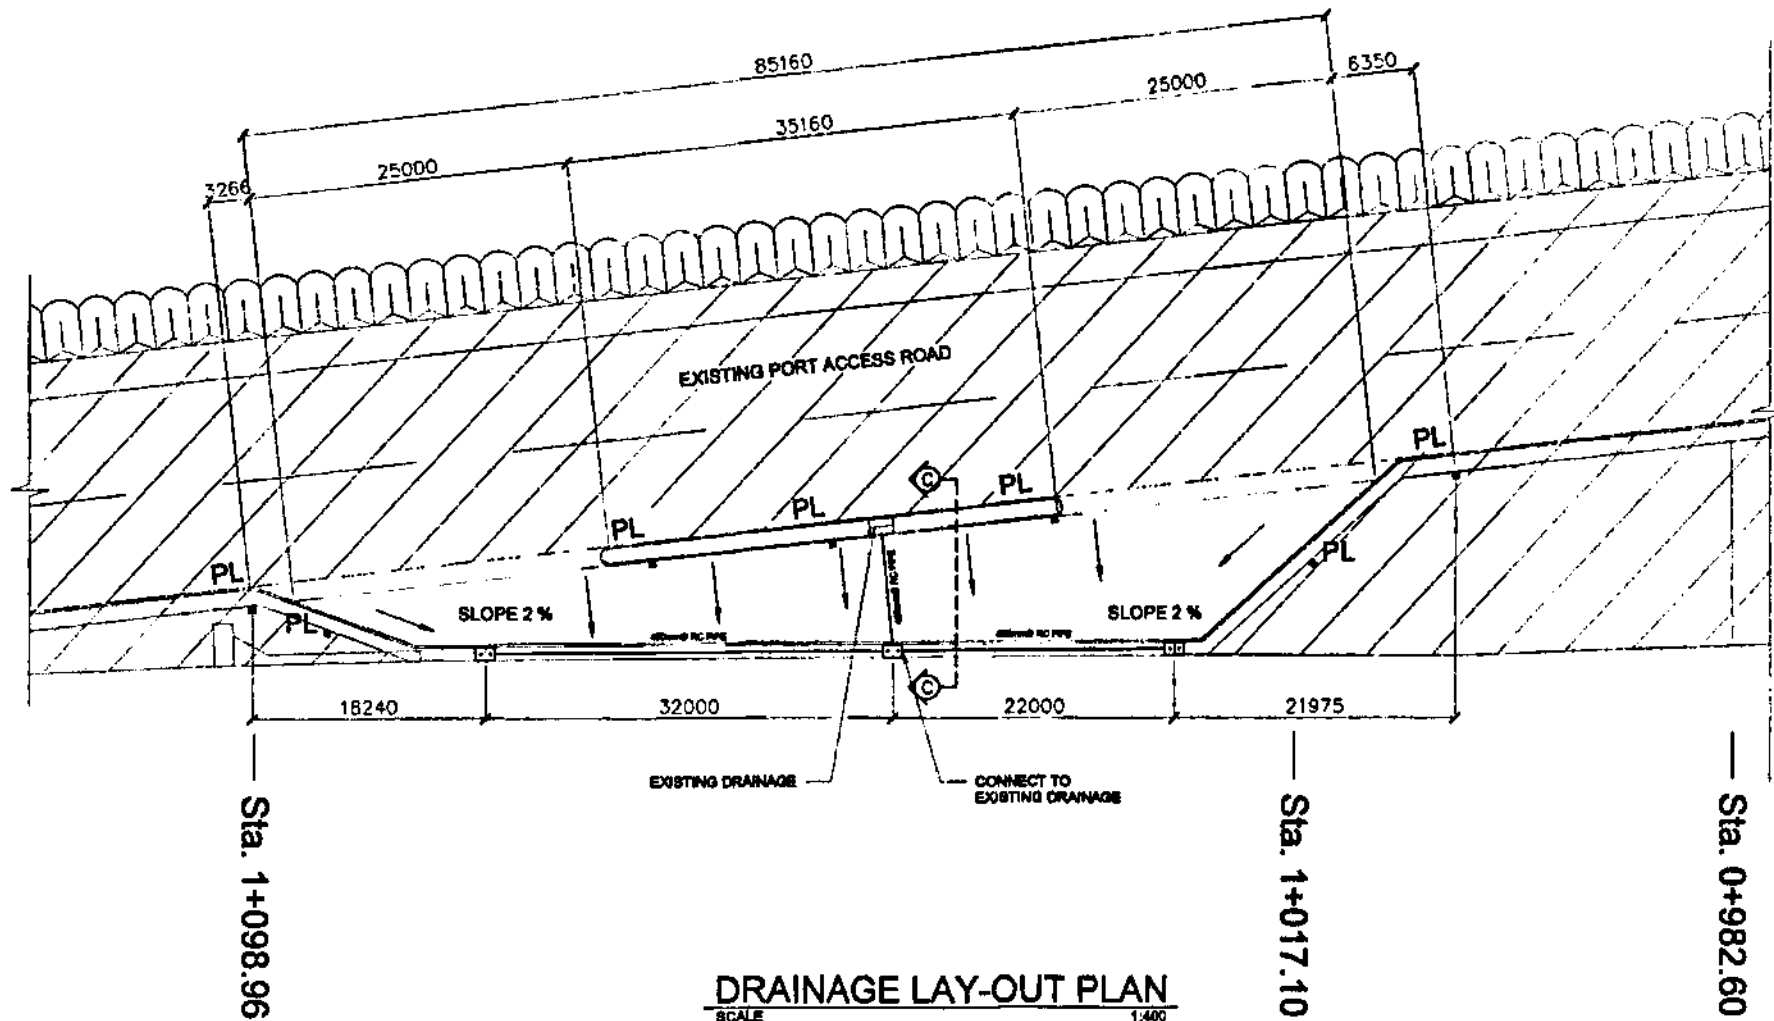DETAIL OF SIDEWALK & GUTTER
SCALE 1:20

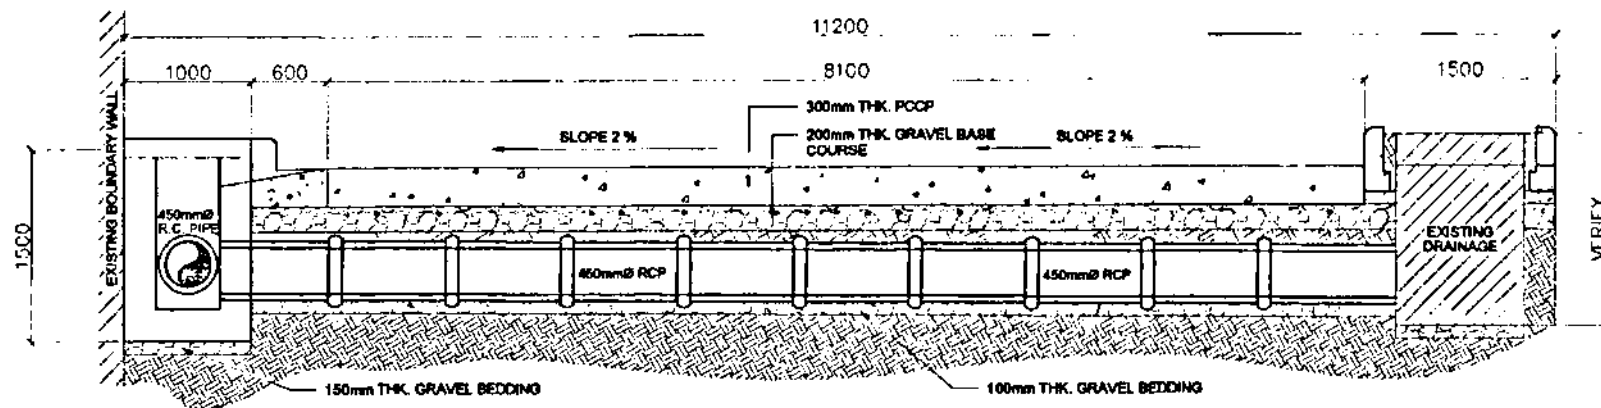

PAINT DETAIL OF R.C. CURB
SCALE 1:20

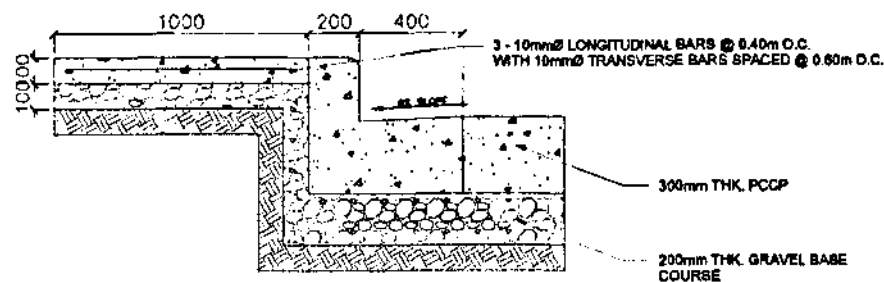 PHILIPPINE PORTS AUTHORITY PORT MANAGEMENT OFFICE - MARQUEZ	PROJECT/LOCATION: PROVISION OF LAY-BY AREA FOR WEIGH-BRIDGE PORT OF LUCENA LUCENA CITY	PREPARED BY:  MARK ANDREW S. PIÑEDA ACTING SUPERVISING ENGINEER A	REVIEWED/RECOMMENDING APPROVAL:  RAUL Y. LIBATIQUE ESD MANAGER	APPROVED:  AURORA A. MENDOZA ACTING PORT MANAGER	SHEET CONTENTS: ● SECTION THRU' - C ● DETAIL OF SIDEWALK & GUTTER ● PAINT DETAIL OF R.C. CURB	SHEET NO. 7/14
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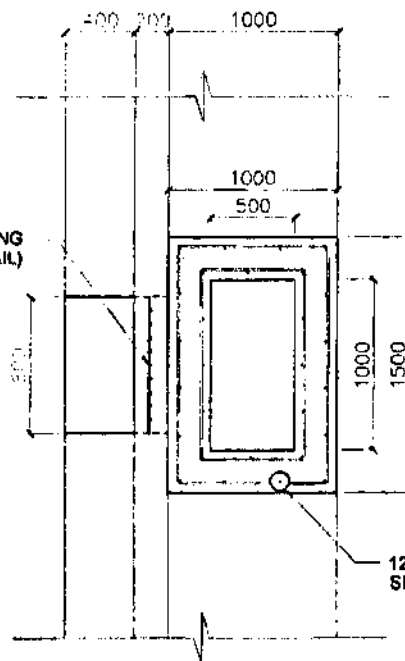


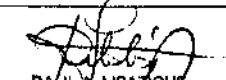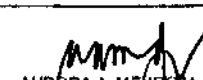**TOP VIEW OF DRAINAGE
INTAKE AND MANHOLE**

SCALE 1:30 MTS

STEEL GRATING
(SEE DETAIL)

MANHOLE COVER
(SEE DETAIL)



PLAN

12mm Ø VERT. REBARS
SPACED AS SHOWN

STEEL GRATING
(SEE DETAIL)

MANHOLE COVER
(SEE DETAIL)

333
200

450mm Ø RCP

CONNECT TO
EXISTING DRAINAGE


150mm THK. GRAVEL BEDDING

12mm Ø HOR. REBARS
SPACED AS SHOWN

SECTION


**DETAIL OF DRAINAGE
INTAKE AND MANHOLE**

SCALE 1:30 MTS

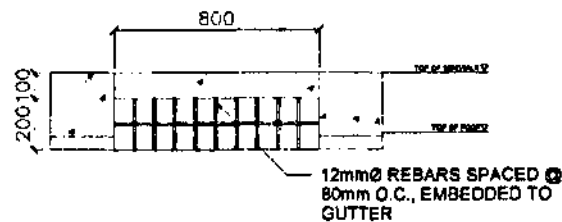

DETAIL OF STEEL GRATING


SCALE 1:30 MTS

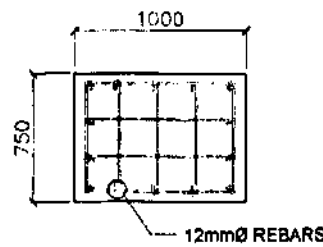





PLAN


DETAIL OF MANHOLE COVER

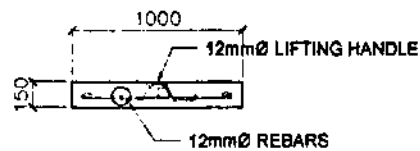SCALE 1:30 MTS




SECTION

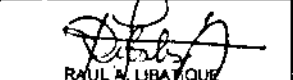 PHILIPPINE PORTS AUTHORITY PORT MANAGEMENT OFFICE - MARQUEZ	PROJECT/LOCATION PROVISION OF LAY-BY AREA FOR WEIGH-BRIDGE PORT OF LUCENA LUCENA CITY	PREPARED BY:  MARK ANDREW S. PINEDA ACTING SUPERVISING ENGINEER A	REVIEWED/RECOMMENDING APPROVAL:  RAUL A. LIBATIQUE ESO MANAGER	APPROVED:  AURORA A. MENDOZA ACTING PORT MANAGER	SHEET CONTENTS • TOP VIEW OF DRAINAGE INTAKE AND MANHOLE • DETAIL OF DRAINAGE INTAKE AND MANHOLE • DETAIL OF STEEL GRATING • DETAIL OF MANHOLE COVER	SHEET NO. 8/14
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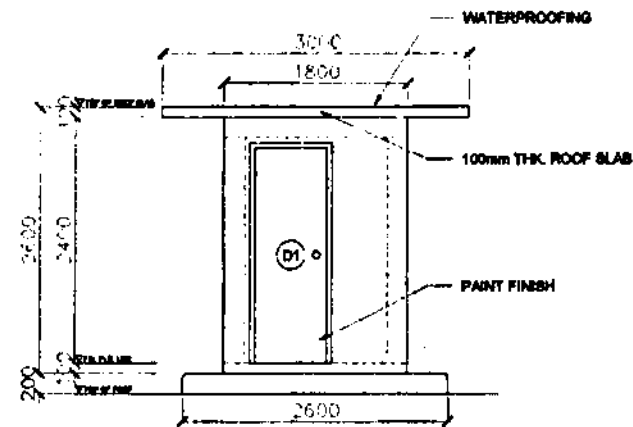
FLOOR PLAN

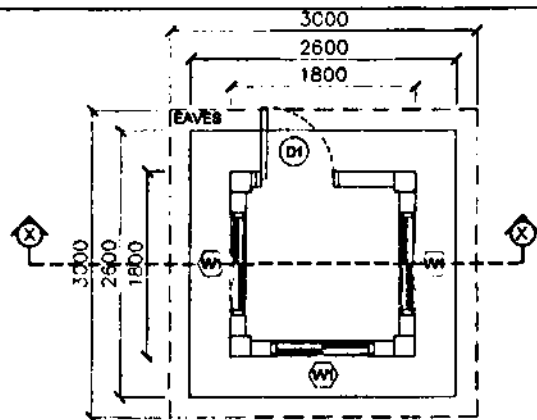SCALE 1:50




FRONT ELEVATION

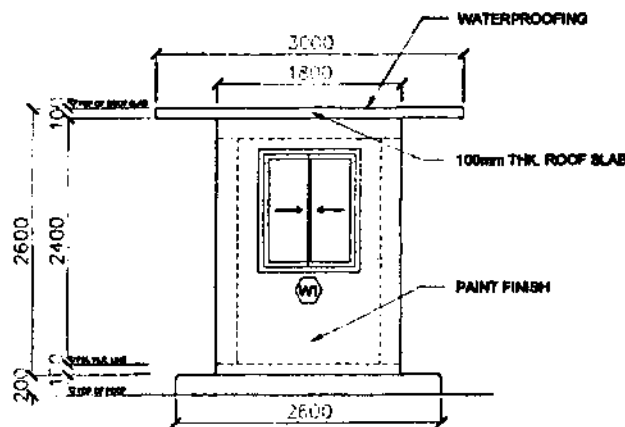SCALE 1:50




REAR ELEVATION

SCALE 1:50

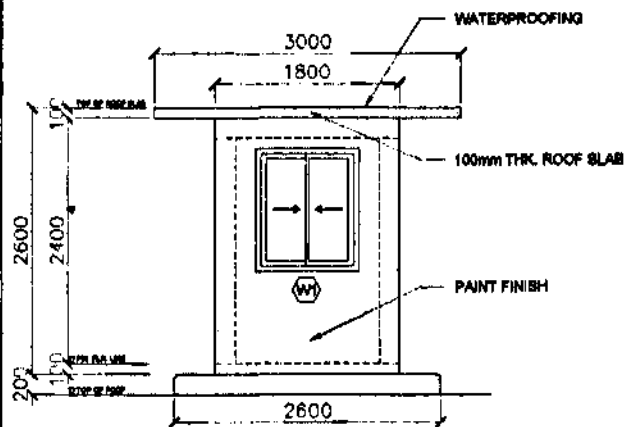


LEFT & RIGHT ELEVATION

SCALE 1:50

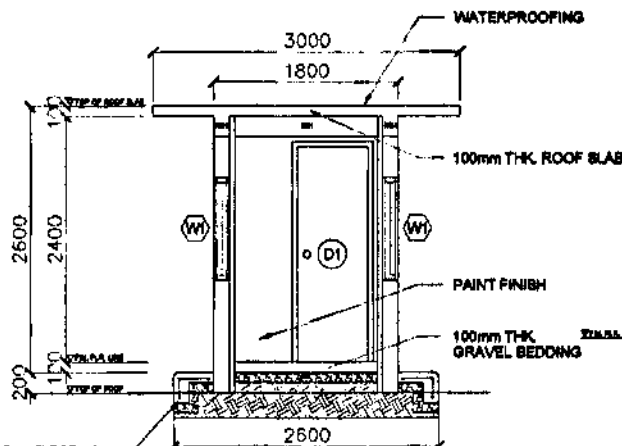

SECTION THRU' - X

SCALE 1:50

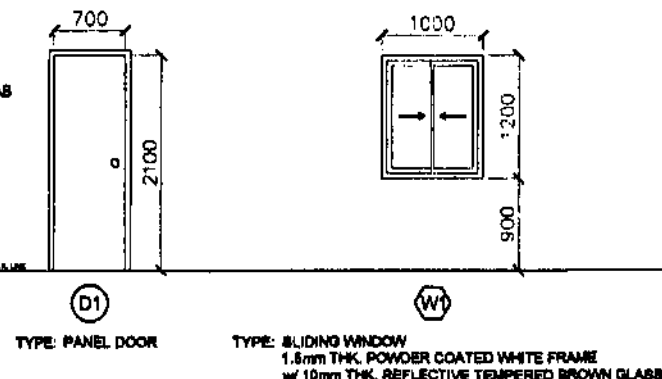

SCHEDULE OF DOORS & WINDOWS

SCALE 1:50





DETAIL OF CONTROL ROOM


NOTE:

FOR PCPP, SIDEWALK & GUTTER
F_c = 32 MPa (4,500 psi)
F_y = 276 MPa (40,000 psi)


FOR SEGREGATION ISLAND
F_c = 32 MPa (4,500 psi)
F_y = 276 MPa (40,000 psi)

FOR WEIGH-BRIDGE CONTROL ROOM
F_c = 24 MPa (3,500 psi)
F_y = 276 MPa (40,000 psi)

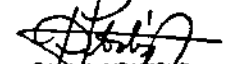 PHILIPPINE PORTS AUTHORITY PORT MANAGEMENT OFFICE - MARQUEZ	PROJECT LOCATION: PROVISION OF LAY-BY AREA FOR WEIGH-BRIDGE PORT OF LUCENA LUCENA CITY	PREPARED BY:  MARK ANDREWS PINEDA ACTING SUPERVISING ENGINEER A	REVIEWED/RECOMMENDING APPROVAL:  RAULA LIBATIQUE ESD MANAGER	APPROVED:  AURORA A. MENDOZA PORT MANAGER	SHEET CONTENTS: • FLOOR PLAN • FRONT ELEVATION • REAR ELEVATION • LEFT & RIGHT ELEVATION • SECTION THRU' - X • SCHEDULE OF DOORS AND WINDOWS	SHEET NO. 9/14
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ROOF FRAMING PLAN
SCALE 1:50

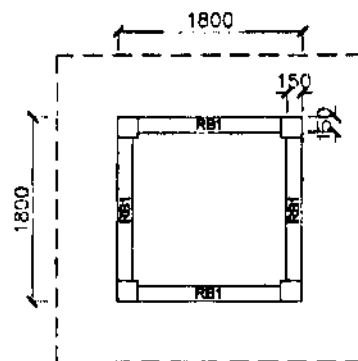


ROOF PLAN
SCALE 1:50

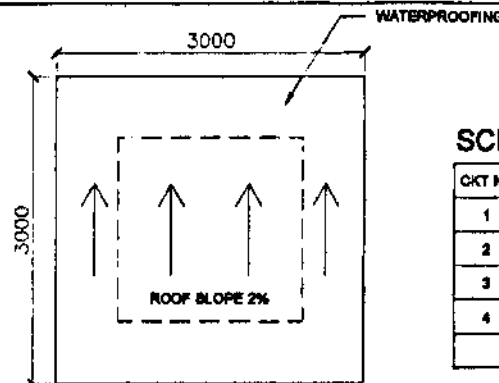SCHEDULE OF LOAD

CKT NO.	DESCRIPTION	NO. OF OUTLET	VOLT.	WATT.	AMP.	CKT Breaker PROTECTION	SIZE OF WIRE mm ²	CONDUIT SIZE mm
1	L.O.	8	230	600	2.17	16 A	2-2.00 mm ²	13 mm
2	C.O.	1	230	200	0.87	20 A	2-3.00 mm ²	13 mm
3	WEIGH-BRIDGE	1	230	200	0.87	20 A	2-3.00 mm ²	13 mm
4	SPARE	-	-	-	-	-	-	-
					3.91 A			

USE: 2-3.50 mm² THIN WIRE AND 1-2.00 mm² THIN WIRE FOR MAIN AND NEUTRAL FEEDER RESPECTIVELY.
1 - 30AT, 2 POLE, 2 WIRE, 230 V FOR MAIN BREAKER

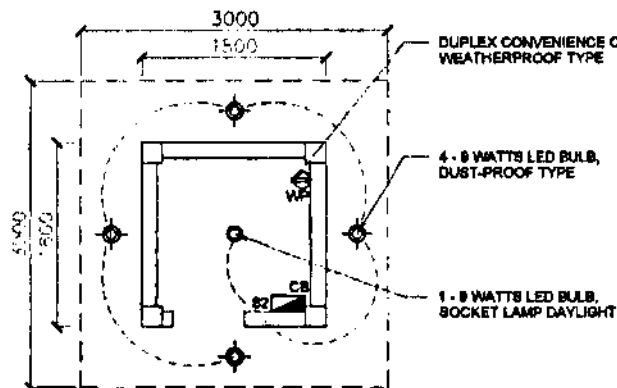


NOTE:
POWER SUPPLY WILL COME
FROM THE EXISTING LINE FROM GATE 4


ELECTRICAL LAY-OUT PLAN
SCALE 1:50

LEGEND:


- 8W LED BULB, DUST-PROOF TYPE
- 8W LED BULB, SOCKET LAMP DAYLIGHT
- ⊕ WP DUPLEX CONVENIENCE OUTLET WEATHERPROOF TYPE
- 8 TWO GANG SWITCH
- ▢ CB 30A CIRCUIT BREAKER

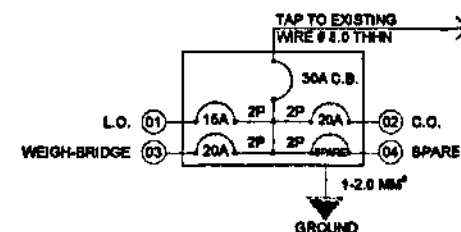

SINGLE LINE DIAGRAM (CONTROL ROOM)

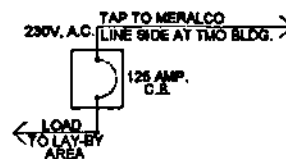

SINGLE LINE DIAGRAM (MAIN PANEL BOARD))

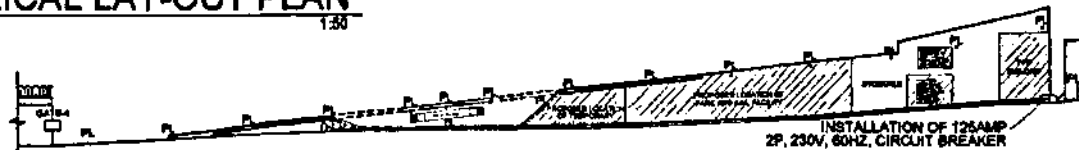

PORT MANAGEMENT OFFICE - MARGUEZ

PROJECT/LOCATION:

**PROVISION OF LAY-BY AREA
FOR WEIGH-BRIDGE**

PORT OF LUCENA

LUCENA CITY

PREPARED BY:

MARK ANDREW S. PIREDA
ACTING SUPERVISING ENGINEER A

REVIEWED/RECOMMENDING APPROVAL:

RUFU A. LIBATIQUE
ESD MANAGER

APPROVED:


AURORA A. NETOZZA
PORT MANAGER

SHEET CONTENTS

- ROOF FRAMING PLAN
- ROOF PLAN
- ELECTRICAL LAY-OUT PLAN
- SCHEDULE OF LOAD

SHEET NO.

10/14

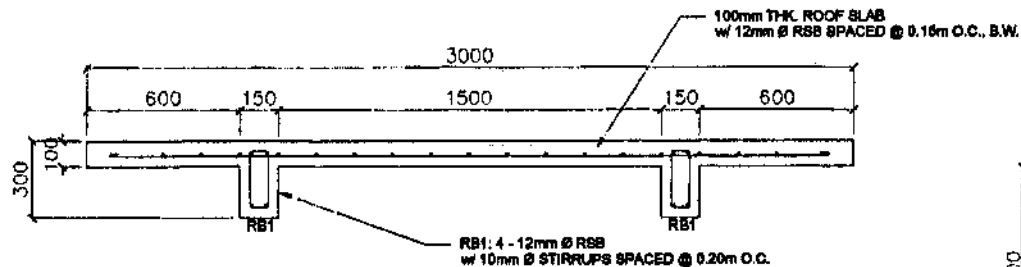

ROOF SLAB & RB1 DETAIL

SCALE



1:20

100mm THK. GRAVEL BEDDING

WALL & WF1 DETAIL

SCALE

1:15

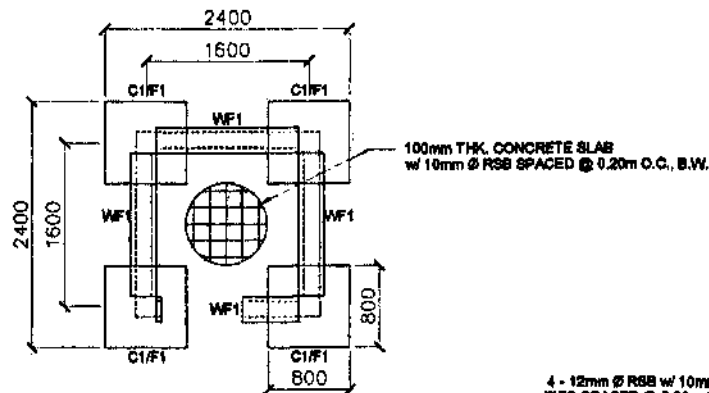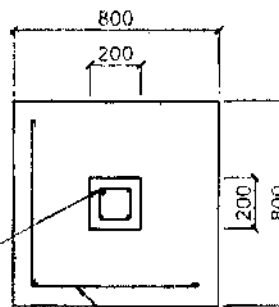

FOUNDATION PLAN

SCALE

1:50


4 - 12mm \varnothing RSB w/ 10mm \varnothing
TIES SPACED @ 0.20m O.C.

8 - 12mm \varnothing RSB BOTHWAYS

C1/F1 DETAIL

SCALE

1:20

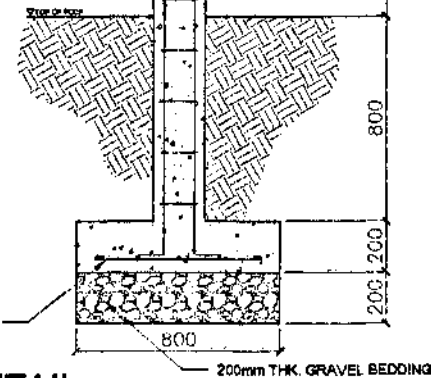

PORT MANAGEMENT OFFICE - MARQUEZ

PROJECT/LOCATION:

**PROVISION OF LAY-BY AREA
FOR WEIGH-BRIDGE**

PORT OF LUCENA

LUCENA CITY

PREPARED BY:

MARK ANDREW S. PINEDA
ACTING SUPERVISING ENGINEER A

REVIEWED/RECOMMENDING APPROVAL:

RAUL A. LIBATON
ESD MANAGER

APPROVED:


AURORA A. MENDOZA
ACTING PORT MANAGER

SHEET CONTENTS


• ROOF SLAB & BEAM DETAIL
• FOUNDATION PLAN
• WALL & WF1 DETAIL
• C1/F1 DETAIL

SHEET NO.


11/14

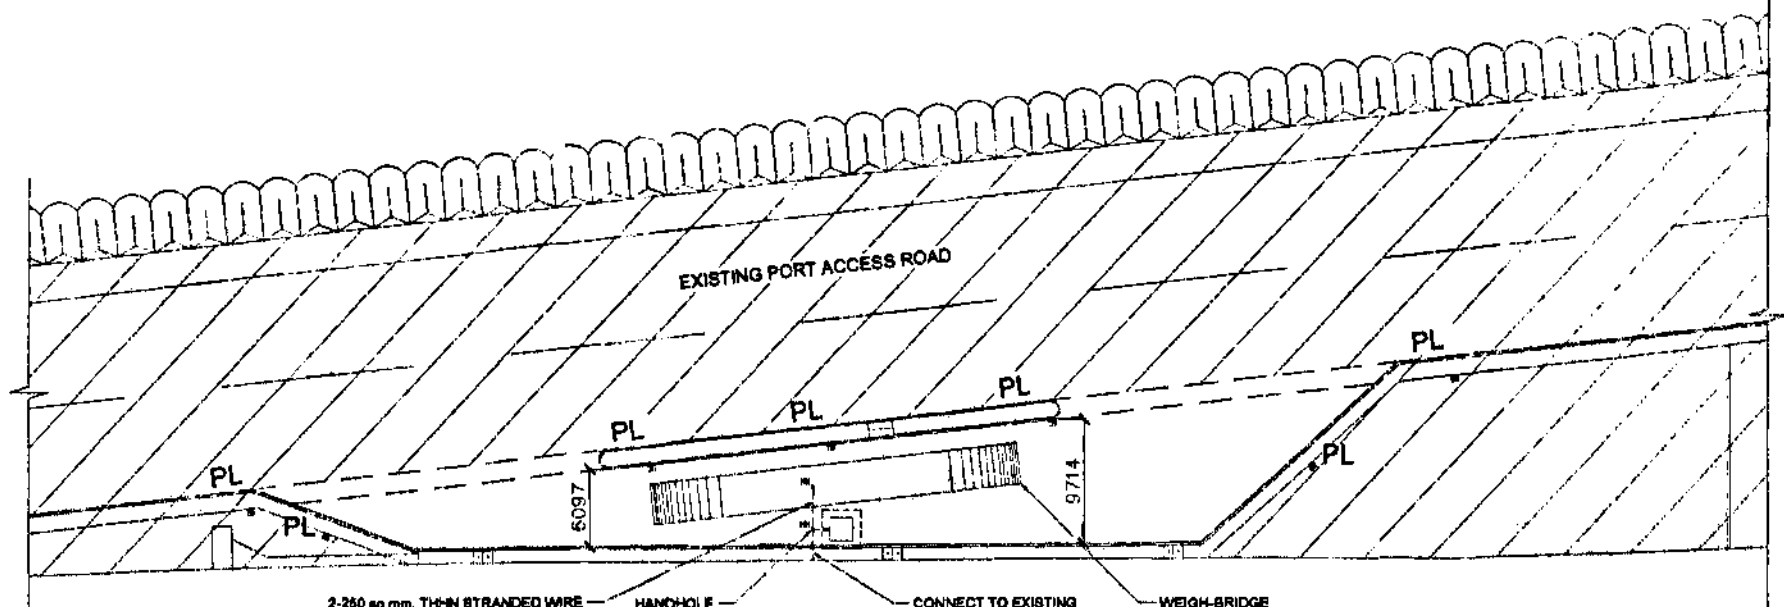


LOCATION PLAN
SCALE 1:400

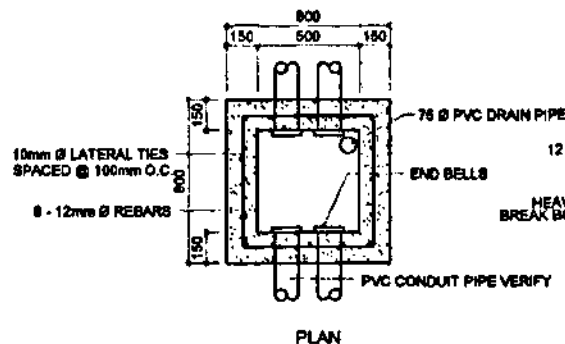


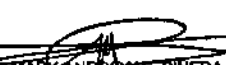


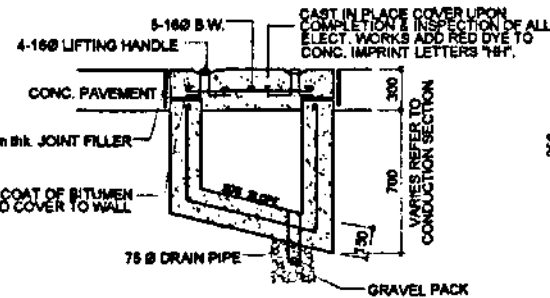DETAIL OF HANDHOLE
SCALE 1:25

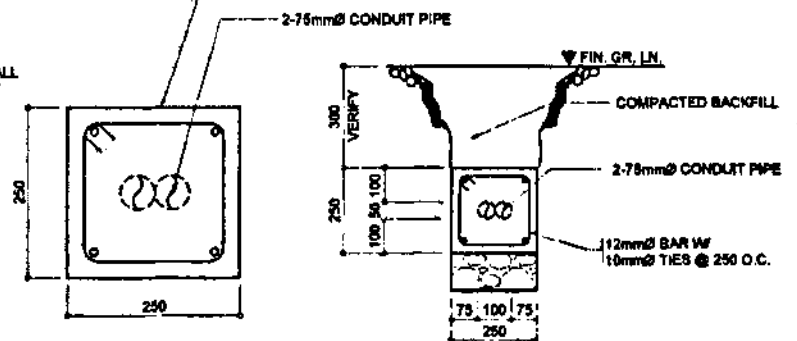


SECTION








DETAIL OF CONCRETE DUCT ENCASEMENT
SCALE 1:10


 PHILIPPINE PORTS AUTHORITY PORT MANAGEMENT OFFICE - MARQUEZ	PROJECT LOCATION PROVISION OF LAY-BY AREA FOR WEIGH-BRIDGE PORT OF LUCENA LUCENA CITY	PREPARED BY:  MARK ANDREWS PINEDA ACTING SUPERVISING ENGINEER A	REVIEWED/RECOMMENDING APPROVAL  RAULA LIBATIQUE ESD MANAGER	APPROVED  AURORA A. MENDOZA ACTING PORT MANAGER	SHEET CONTENTS • LOCATION PLAN • DETAIL OF HANDHOLE • DETAIL OF CONCRETE DUCT ENCASEMENT	SHEET NO. 12/14

LEGEND:

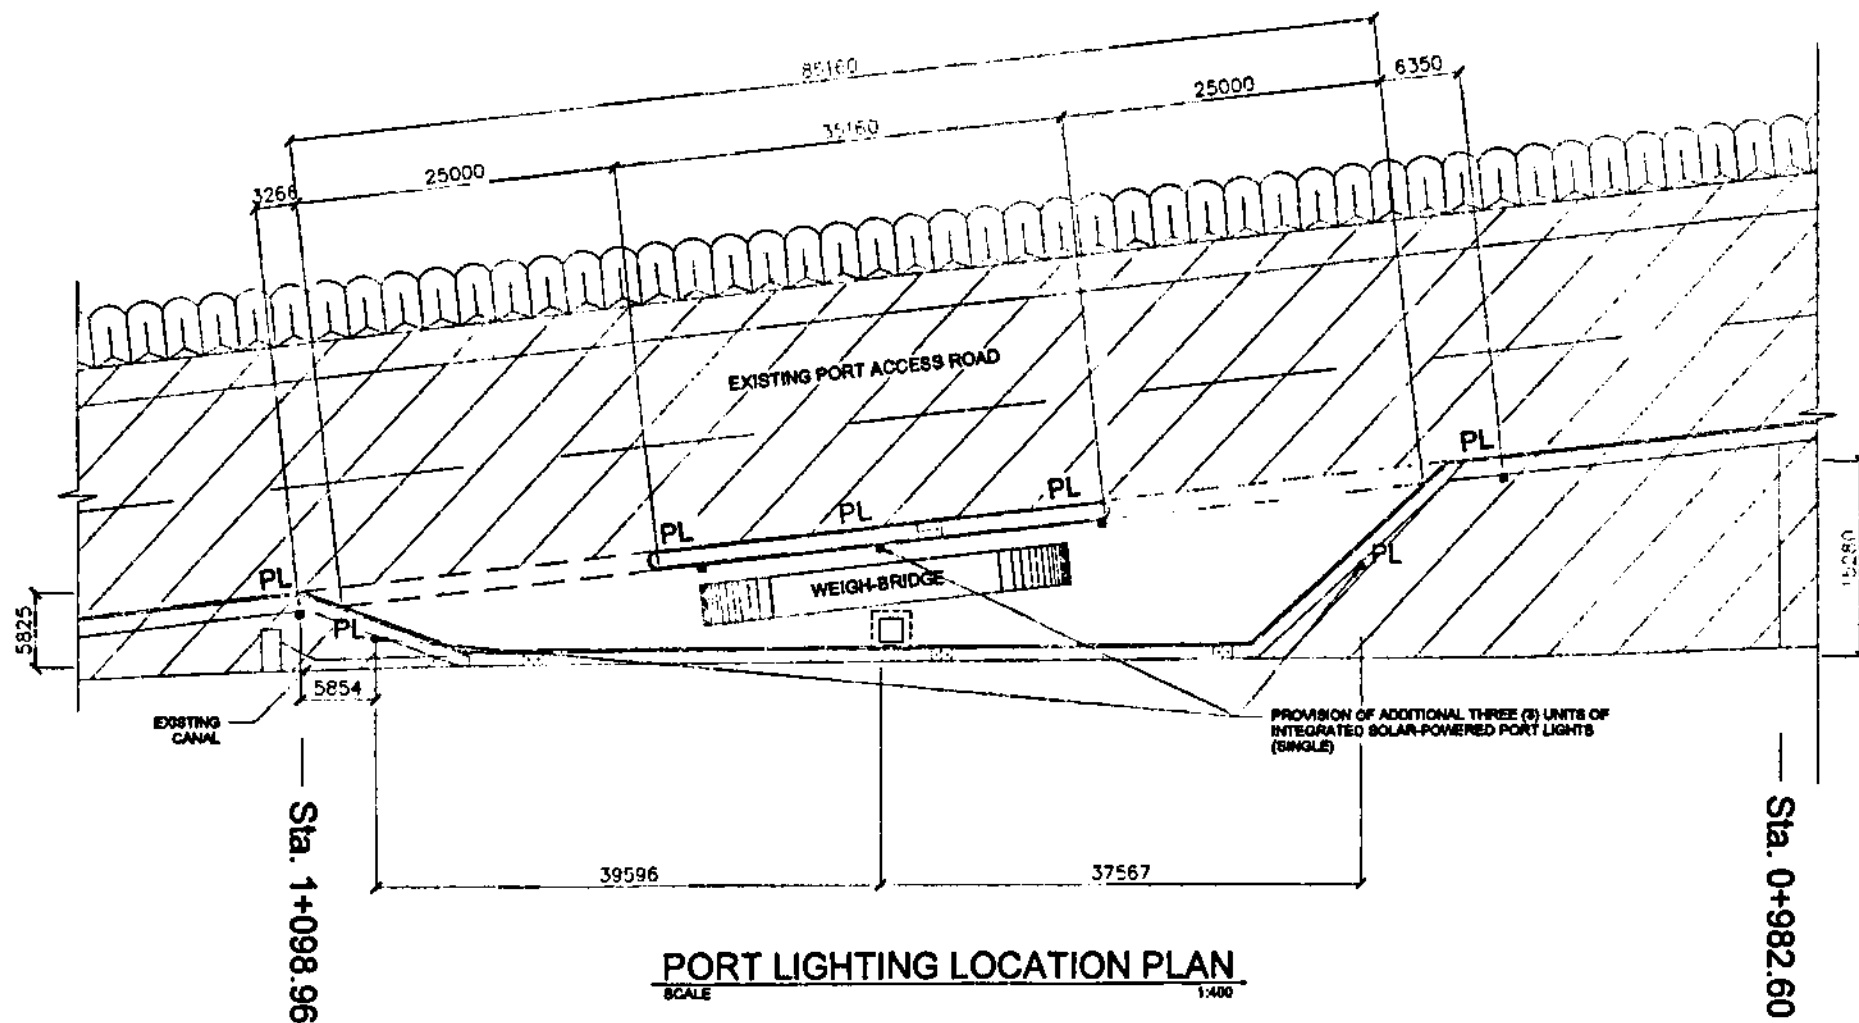PL  - INSTALLATION OF INTEGRATED SOLAR-POWERED PORT LIGHTING (SINGLE)

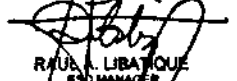

 PHILIPPINE PORTS AUTHORITY PORT MANAGEMENT OFFICE - MARQUEZ	PROJECT/LOCATION: PROVISION OF LAY-BY AREA FOR WEIGH-BRIDGE PORT OF LUCENA LUCENA CITY	PREPARED BY:  MARK ANDREW S. PINEDA ACTING SUPERVISING ENGINEER A	REVIEWED/RECOMMENDING APPROVAL:  RAUL A. LIBATIQUE ESD MANAGER	APPROVED:  AURORA A. MENDOZA PORT MANAGER	SHEET CONTENTS: ● PORT LIGHTING LOCATION PLAN	SHEET NO. 13/14
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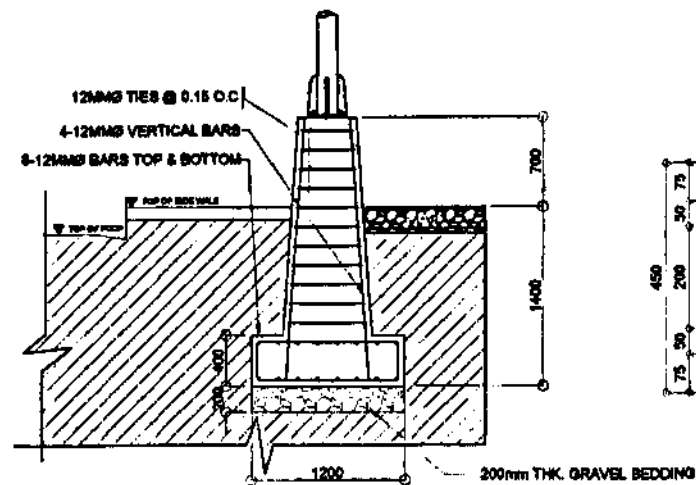
DETAIL OF INTEGRATED SOLAR-POWERED PORT LIGHTS (SINGLE)

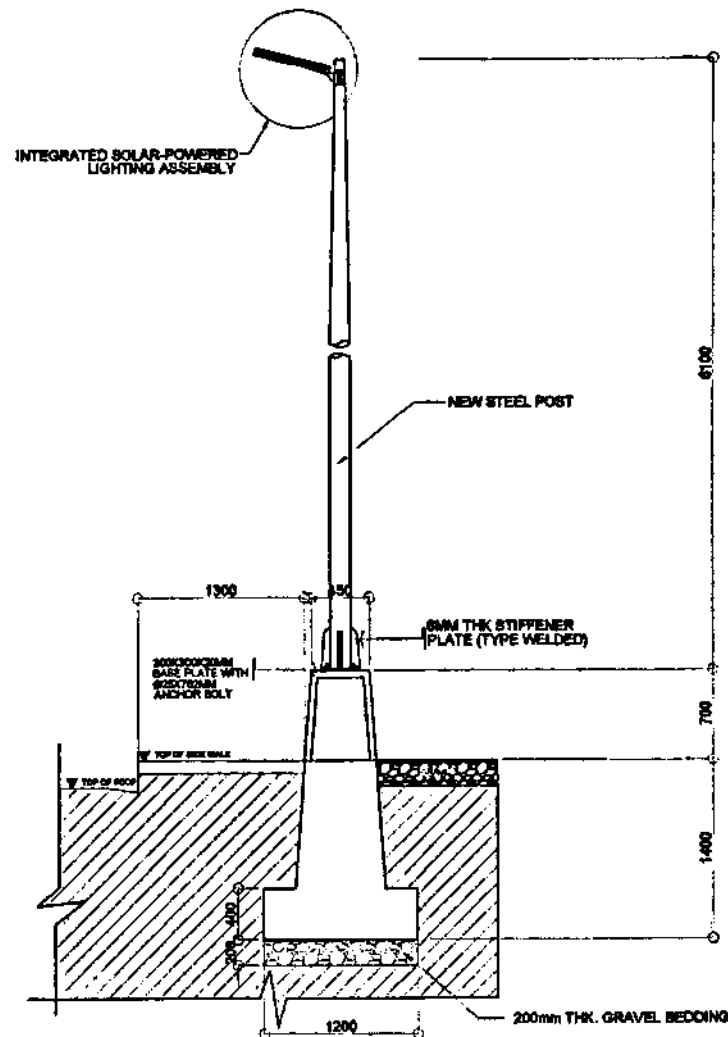SCALE

1:40

SPECIFICATION: INTEGRATED SOLAR-POWERED LIGHTING ASSEMBLY


ITEM	DESCRIPTION
120W LED LAMP (147.00x67.3x43.00 CM; 45.0KG)	12,000-13,200 LUMENS DC30V POWER INPUT
LITHIUM BATTERY	12V / 59AH
SOLAR PANEL (POLYCRYSTAL SILICON)	36V / 170W



DETAIL OF PEDESTAL POST

SCALE

1:40

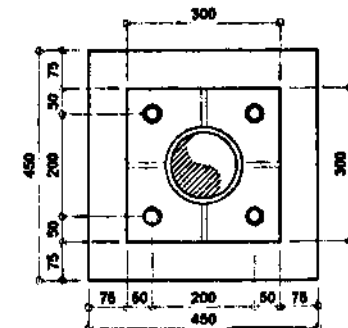

BASE PLATE DETAIL

SCALE

1:10

PHILIPPINE PORTS AUTHORITY PORT MANAGEMENT OFFICE - MARQUEZ	PROJECT/LOCATION:	PREPARED BY:	REVIEWED/RECOMMENDING APPROVAL:	APPROVED:	SHEET CONTENTS	SHEET NO.
	PROVISION OF LAY-BY AREA FOR WEIGH-BRIDGE PORT OF LUCENA LUCENA CITY	MARK ANDREW S. PINEDA ACTING SUPERINTENDING ENGINEER A	RAUL A. LIBATIQUE ESD MANAGER	AURORA A. MENDOZA PORT MANAGER	• DETAIL OF INTEGRATED SOLAR-POWERED PORT LIGHTS (SINGLE) • SPECIFICATIONS • DETAIL OF PEDESTAL POST • BASE PLATE DETAIL	14/14

SECTION VIII

BILL OF QUANTITIES
and
ATTACHMENTS

BID SUMMARY
PROVISION OF LAY-BY AREA FOR WEIGH BRIDGE
PORT OF LUCENA, LUCENA CITY



NO.	DESCRIPTION OF WORK	AMOUNT (Pesos)
BILL NO. 1	GENERAL EXPENSES	
BILL NO. 2	PROVISION OF LAY-BY AREA (820.00 SQ.M.) ✓	
BILL NO. 3	PROVISION OF INTEGRATED SOLAR-POWERED PORT LIGHT (3-UNITS)	
BID PRICE		-

Name of Firm

Name of Bidder/Authorized Representative
(Signatory's Legal Capacity)

Date

BILL OF QUANTITIES
PROVISION OF LAY-BY AREA FOR WEIGH BRIDGE
PORT OF LUCENA, LUCENA CITY



NO. (1)	DESCRIPTION OF WORK (2)	UNIT (3)	QTY. (4)	UNIT PRICE (Pesos) (5)	AMOUNT (Pesos) (6)
BILL NO. 1	GENERAL EXPENSES				
1.01	Mobilization/Demobilization and Cleaning-up	/ l.s.	1.00		
1.02	Provision of Construction Safety and Health Program and Project Bulletin Board	/ lot	1.00		
TOTAL FOR BILL NO. 1					-

Name of Bidder/Authorized Representative
(Signatory's Legal Capacity)

BILL OF QUANTITIES
PROVISION OF LAY-BY AREA FOR WEIGH BRIDGE
PORT OF LUCENA, LUCENA CITY



NO. (1)	DESCRIPTION OF WORK (2)	UNIT (3)	QTY. (4)	UNIT PRICE (Pesos) (5)	AMOUNT (Pesos) (6)
BILL NO. 2	PROVISION OF LAY-BY AREA (820.00 SQ.M.)				
2.01	Demolition of Existing Sidewalk including Disposal	sq.m.	165.00		
2.02	Clearing, Grubbing and Scarifying of Unsuitable Materials including Disposal	sq.m.	820.00		
2.03	Excavation of Existing Materials	cu.m.	679.00		
2.04	Supply, Place and Compact 250mm thk. Selected Fill Materials (for corrections due to uneven ground surface)	cu.m.	141.00		
2.05	Supply and Place Gravel Base Course	cu.m.	141.00		
2.06	Concrete Works				
	a.) Supply and Place 4,500 psi Concrete for Portland Cement Concrete Pavement, PCCP	sq.m.	524.00		
	b.) Supply and Place 4,500 psi Concrete for Weigh-Bridge Foundation, Drainage, Segregation Island and Sidewalk & Gutter	cu.m.	53.00		
	c.) Supply and Place 3,500 psi Concrete for Control Room	cu.m.	4.00		
SUB - TOTAL FOR BILL NO. 2 (A)					-

Name of Bidder/Authorized Representative
(Signatory's Legal Capacity)

BILL OF QUANTITIES
PROVISION OF LAY-BY AREA FOR WEIGH BRIDGE
PORT OF LUCENA, LUCENA CITY



NO. (1)	DESCRIPTION OF WORK (2)	UNIT (3)	QTY. (4)	UNIT PRICE (Pesos) (5)	AMOUNT (Pesos) (6)
2.07	Steel Works				
	a.) Supply and Install Temperature Bars for Item 2.05(a)	✓ kg.	✓ 8,965.00		
	b.) Supply and Install Reinforcing Steel Bars for Item 2.05(b) and 2.05©	✓ kg.	✓ 2,545.00		
2.08	Masonry Works	✓ sq.m.	✓ 15.00		
2.09	Supply and Install Doors and Windows including Accessories	✓ sq.m.	✓ 5.07		
2.10	Electrical Works	✓ lot	✓ 1.00		
2.11	Supply and Lay 450mm Ø Reinforced Concrete Pipe for Drainage	✓ ln.m.	✓ 60.00		
2.12	Painting Works	✓ sq.m.	✓ 104.00		
2.13	Provision of Landscaping Materials for Segregation Island	✓ sq.m.	✓ 44.00		
SUB - TOTAL FOR BILL NO. 2 (B)					-
TOTAL FOR BILL NO. 2 (A + B)					-

Name of Bidder/Authorized Representative
(Signatory's Legal Capacity)

BILL OF QUANTITIES
PROVISION OF LAY-BY AREA FOR WEIGH BRIDGE
PORT OF LUCENA, LUCENA CITY



NO. (1)	DESCRIPTION OF WORK (2)	UNIT (3)	QTY. (4)	UNIT PRICE (Pesos) (5)	AMOUNT (Pesos) (6)
BILL NO. 3	PROVISION OF INTEGRATED SOLAR-POWERED PORT LIGHT (3-UNITS)				
3.01	Supply and Place Concrete for Pedestal Post including Steel Reinforcements	sets	3.00		
3.02	Supply and Install Port Lighting Post with Integrated Solar-Powered Port Lighting	set	3.00		
3.03	Painting Works	sq.m.	5.00		
TOTAL FOR BILL NO. 3					-

Name of Bidder/Authorized Representative
(Signatory's Legal Capacity)

BASIS OF PAYMENT FOR WORK ITEMS INCLUDED IN THE PROPOSAL

The work items included in the proposal and the basis of payments are as follows:

BILL NO. 1

GENERAL EXPENSES

Item 1.01 Mobilization, demobilization, and cleaning

The quantity to be paid for shall be the minimum equipment requirement enumerated in the bid documents mobilized, demobilized and cleaning of the site and accepted by the Engineer. The contract lump sum price shall be full compensation for furnishing all materials, labor, equipment, tools, and incidentals necessary to mobilize and demobilize all the minimum equipment requirement enumerated in the bid documents including cleaning of the site. Fifty percent (50%) of the total amount shall be payable after the mobilization activity while the remaining (50%) payable after demobilization and cleaning.

Item 1.02 Provision of Construction Safety and Health Program and Project Bulletin Board

The quantity to be paid for shall be the actual implementation of construction safety and health program and accepted by the Engineer. The contract unit price shall be full compensation for furnishing all materials, labor, equipment, tools, and incidentals necessary to complete the implementation of the Construction Safety and Health Program, as required and approved by the Department of Labor and Employment (DOLE).

BILL NO. 2

PROVISION OF LAY-BY AREA (820.00 SQ.M.)

Item 2.01 Demolition of Existing Sidewalk including Disposal

The quantity to be paid for shall be the actual area in square meter of demolished and disposed 250mm thick concrete sidewalk in accordance with the plans and specifications and accepted by the Engineer. The contract unit price shall be full compensation for labor, equipment, tools, and incidentals necessary to complete the work.

Item 2.02 Clearing, Grubbing and Scarifying of Unsuitable Materials including Disposal

The quantity to be paid for shall be the actual area in square meter of cleared, grubbed and scarified unsuitable materials in accordance with the plans and specifications and accepted by the Engineer. The contract unit price shall be full compensation for labor, equipment, tools, and incidentals necessary to complete the work.

Item 2.03 Excavation of Existing Materials

The quantity to be paid for shall be the actual volume in cubic meter of excavated materials in accordance with the plans and specifications and accepted by the Engineer. The contract unit price shall be full compensation for labor, equipment, tools, and incidentals necessary to complete the work.

**Item 2.04 Supply, Place and Compact 250mm thk. Selected Fill Materials
(for correction due to un-even ground surface)**

The quantity to be paid for shall be the actual volume in cubic meter of supplied and compacted selected fill materials in accordance with the plans and specifications and accepted by the Engineer. The contract unit price shall be full compensation for furnishing all materials, labor, equipment, tools, and incidentals necessary to complete the work.

Item 2.05 Supply and Place Gravel Base Course

The quantity to be paid for shall be the actual volume in cubic meter of supplied and placed gravel base course in accordance with the plans and specifications and accepted by the Engineer. The contract unit price shall be full compensation for furnishing all materials, labor, equipment, tools, and incidentals necessary to complete the work.

Item 2.06 (a) Supply and Place 4,500 psi Concrete for Portland Cement Concrete Pavement, PCCP

The quantity to be paid for shall be the actual area in square meter of supplied and placed 4,500 psi portland cement concrete in accordance with the plans and specifications and accepted by the Engineer. The contract unit price shall be full compensation for furnishing all materials, labor, equipment, tools, and incidentals necessary to complete the work.

Item 2.06 (b) Supply and Place 4,500 psi Concrete for Weigh-Bridge Foundation, Drainage, Segregation Island and Sidewalk & Gutter

The quantity to be paid for shall be the actual volume in cubic meter of supplied and placed 4,500 psi concrete for weigh-bridge foundation, drainage, segregation island and sidewalk & gutter in accordance with the plans and specifications and accepted by the Engineer. The contract unit price shall be full compensation for furnishing all materials, labor, equipment, tools, and incidentals necessary to complete the work.

Item 2.06 (c) Supply and Place 3,500 psi Concrete for Control Room

The quantity to be paid for shall be the actual volume in cubic meter of supplied and placed 3,500 psi concrete for control room in accordance with the plans and specifications and accepted by the Engineer. The contract unit price shall be full compensation for furnishing all materials, labor, equipment, tools, and incidentals necessary to complete the work.

Item 2.07 (a) Supply and Install Temperature Bars for Item 2.05(a)

The quantity to be paid for shall be the actual weight in kilograms of installed temperature bars in accordance with the plans and specifications and accepted by the Engineer. The contract unit price shall be full compensation for furnishing all materials, labor, equipment, tools, and incidentals necessary to complete the work.

Item 2.07 (b) Supply and Install Reinforcing Steel Bars for Item 2.05(b) and 2.05(c)

The quantity to be paid for shall be the actual weight in kilograms of installed temperature bars in accordance with the plans and specifications and accepted by the Engineer. The contract unit price shall be full compensation for furnishing all materials, labor, equipment, tools, and incidentals necessary to complete the work.

Item 2.08 Masonry Works

The quantity to be paid for shall be the actual area in square meter of completed masonry works in accordance with the plans and specifications and accepted by the Engineer. The contract unit price shall be full compensation for furnishing all materials, labor, equipment, tools, and incidentals necessary to complete the work.

Item 2.09 Supply and Install Doors and Windows including accessories

The quantity to be paid for shall be the actual area in square meter of installed doors and windows in accordance with the plans and specifications and accepted by the Engineer. The contract unit price shall be full compensation for furnishing all materials, labor, equipment, tools, and incidentals necessary to complete the work.

Item 2.10 Electrical Works

The quantity to be paid for shall be the completeness of the installation of electrical works in accordance with the plans and specifications and accepted by the Engineer. The contract unit price shall be full compensation for furnishing all materials, labor, equipment, tools, and incidentals necessary to complete the work.

Item 2.11 Supply and Lay 450mm dia. Reinforced Concrete Pipe for Drainage

The quantity to be paid for shall be the actual length in linear meter of installed reinforce concrete pipe in accordance with the plans and specifications and accepted by the Engineer. The contract unit price shall be full compensation for furnishing all materials, labor, equipment, tools, and incidentals necessary to complete the work.

Item 2.12 Painting Works

The quantity to be paid for shall be the actual area in square meter of painted surfaces in accordance with the plans and specifications and accepted by the Engineer. The contract unit price shall be full compensation for furnishing all materials, labor, equipment, tools, and incidentals necessary to complete the work.

Item 2.13 Provision of Landscaping Materials for Segregation Island

The quantity to be paid for shall be the actual area in square meter of planted plants and other landscaping materials for segregation island in accordance with the plans and specifications and accepted by the Engineer. The contract unit price shall be full compensation for furnishing all materials, labor, equipment, tools, and incidentals necessary to complete the work.

BILL NO. 3

PROVISION OF INTEGRATED SOLAR-POWERED PORT LIGHT (3-UNITS)

Item 3.01 Supply and Place Concrete for Pedestal Post including Steel Reinforcements

The quantity to be paid for shall be the actual number of completed pedestal posts in for concreted pedestal posts including steel reinforcements in accordance with the plans and specifications and accepted by the Engineer. The contract unit price shall be full compensation for furnishing all materials, labor, equipment, tools, and incidentals necessary to complete the work.

Item 3.02 Supply and Install Port Lighting Post with Integrated Solar-Powered Port Lighting complete with fittings and accessories

The quantity to be paid for shall be the actual number of installed posts with integrated solar-powered port in accordance with the plans and specifications and accepted by the Engineer. The contract unit price shall be full compensation for furnishing all materials, labor, equipment, tools, and incidentals necessary to complete the work.

Item 3.03 Painting Works

The quantity to be paid for shall be the actual area in square meter of painted surfaces in accordance with the plans and specifications and accepted by the Engineer. The contract unit price shall be full compensation for furnishing all materials, labor, equipment, tools, and incidentals necessary to complete the work.

MINIMUM MAJOR EQUIPMENT REQUIREMENTS**Required Equipment (Owned/Leased):**

2	unit/s	Jackhammer	owned/leased
2	unit/s	Air compressor (250 cfm)	owned/leased
1	unit/s	Payloader (1.30 cu.m., 78hp)	owned/leased
1	unit/s	Dump truck (12 cu.yd.)	owned/leased
1	unit/s	Concrete cutter, 7.5 hp	owned/leased
1	unit/s	Backhoe (0.50cu.m./132hp)	owned/leased
1	unit/s	Road Roller, 10MT, 130hp	owned/leased
1	unit/s	Conc. mixer (1-bagger)	owned/leased
1	unit/s	Concrete Vibrator, 3.5 hp	owned/leased
1	unit/s	Water Truck with pump (1000 gal.)	owned/leased
1	unit/s	Bar cutter (electric, 25mm dia min.)	owned/leased
1	unit/s	Bar Bender, (electric, 25mm dia min.)	owned/leased
1	unit/s	Truck Mounted Hydraulic Telescopic Boom, 100hp, 2MT	owned/leased

CONSTRUCTION SAFETY AND HEALTH REQUIREMENT

The Contractor shall implement the construction safety and health program in accordance with the applicable provisions of the Occupational Safety and Health Standards (OSHS) of the Department of Labor and Employment (DOLE).

The Contractor, subject to the approval of the Engineer shall provide and maintain throughout the duration of the contract a medical room with at least 15 square meters together with all necessary supplies to be sited in the Contractor's main area.

The Contractor shall provide the following minimum requirements:

LABOR

1	no.	Safety Engineer / Officer
1	no.	Nurse / Health Officer

EQUIPMENT / MATERIALS

Personnel Protective Equipment

30	pcs.	Hard Hats
30	pairs	Gloves (rubberized)
30	pairs	Safety Shoes
30	pcs	Reflective safety Vest

Safety Devices

1	lot	Barricades
1	lot	Warning signs

Medical and First Aid System - One-Hundred Thirty Five (135 C.D.)

NOTE:

The Contractor shall provide the above-cited minimum construction safety and health requirements or as required by the Engineer.

PPA MEMORANDUM CIRCULAR
No. 02
Series of 2018
Attachment
Page 1 of 10

**REVISED SCHEDULE OF MINIMUM TEST REQUIREMENTS OF
CONSTRUCTION MATERIALS FOR PPA INFRASTRUCTURE PROJECTS**

Materials/Items of Work	Required Tests	Minimum Incremental Frequency of Tests
I. Construction of Pier/Wharf, Platform and Ramp		
Structural Concrete (SC)		
A Portland Cement	Quality Test	For every 2,000 bags (40kg) or fraction thereof
B Fine Aggregate	Quality Test for Grading, Elutriation (wash), Bulk Specific Gravity, Absorption, Mortar Strength, Soundness, Organic Impurities, Unit Weight, % Clay Lumps and Shale	For every 1,500 cubic meter or fraction thereof
C Coarse Aggregate	Quality Test for Grading, Bulk Specific Gravity, Absorption and Abrasion	For every 1,500 cubic meter or fraction thereof
D Water	Certificate from the Engineer or Quality Test for Density and Chloride Content	One per source
E Steel Bars	Mill Certificate and Quality Test for Chemical Composition and Mechanical Properties	For every 10,000 kg or fraction thereof
F Concrete	Compressive Strength on cylinder samples	1 set consisting of 3 concrete cylinder samples shall be taken from each day's pouring and to represent not more than 75 cu m of concrete or fraction thereof
	Slump Test	For every mix
G Admixture and Concrete Curing Materials	Quality Test	One per shipment
Piling (P)		
A Concrete Piles	Fabrication Report	One per fabrication
1 Concrete	Same test as for SC (F)	Same frequency as SC (F)
2 Steel Bars	Same test as for SC (E)	Same frequency as SC (E)
3 High Tension Strand	Test for Chemical Composition and Mechanical Properties	For every 20000kg or fraction thereof

PPA MEMORANDUM CIRCULAR
No. 02
Series of 2016
Attachment

Page 2 of 10

Materials/Items of Work	Required Tests	Minimum Incremental Frequency of Tests
4 Coarse Aggregates	Same Test as for SC (C)	Same frequency as SC (C)
5 Fine Aggregates	Same Test as for SC (B)	Same frequency as SC (B)
B Steel Pipe Piles	Fabrication Report, Mill Certificate and Quality Test for Chemical and Mechanical properties	One per fabrication
1 Steel	Chemical Composition (refer below) <ul style="list-style-type: none"> Under 14" (355 60mm) Outside Diameter 14" to 36" (355 6 to 914mm) Outside Dia Over 36" (914mm) Outside Diameter Mechanical/Tensile	2 from 200 pipe or fraction thereof 2 from 100 pipe or fraction thereof 2 from 3000ft (914m) or fraction thereof One (1) tension test shall be made on one length or fraction thereof of each size, or one piece of skelp representing each lot of 200 lengths or fraction thereof of each size
2 Polyurethane Coating	Mill Certificate and Quality Test	One per fabrication
3 Concrete	Same test as for SC (F)	Same frequency as SC (F)
4 Fine Aggregate	Same test as for SC (B)	Same frequency as SC (B)
5 Coarse Aggregate	Same test as for SC (C)	Same frequency as SC (C)
6 Steel Bars	Same Test as SC (E)	Same frequency as SC (E)
7 Water	Same Test as SC (D)	Same frequency as SC (D)
Rubber Dock Fenders (RDF)	Physical Test Performance Test for Energy Absorption and Reaction Force	All units All units
Accessories		
Washer and Fixing Bolt, Anchor Bolt	Physical Test Quality Test for Chemical Composition and Mechanical Properties	All units One per fabrication

PPA MEMORANDUM CIRCULAR
No. 02
Series of 2016
Attachment
Page 3 of 10

Materials/Items of Work	Required Tests	Minimum Incremental Frequency of Tests
Mooring Bollard (MB) and Accessories (Hexagon Nuts, Plain Washer, Anchor Ring and Anchor Bolt)	Physical Test Quality Test for Chemical Composition and Mechanical Properties	All Units One per fabrication
II. Construction of Back-Up Area, Causaway and Pavement		
Sheet Piling (SP)		
A Concrete Sheet Piles		
1 Concrete	Same test as for SC (F)	Same frequency as SC (F)
2 Steel Bars	Same test as for SC (E)	Same frequency as SC (E)
3 High Tension Strands	Same test as for P (A 3)	Same frequency as P (A 3)
4 Fine Aggregates	Same test as for SC (B)	Same frequency as SC (B)
5 Coarse Aggregates	Same Test as for SC (C)	Same frequency as SC (C)
B Steel Pipe Piles		
1 Steel	Same test as for P (B1)	Same frequency as P (B1)
2 Concrete	Same test as for SC (F)	Same frequency as SC (F)
3 Fine Aggregate	Same test as for SC (B)	Same frequency as SC (B)
4 Steel Bars	Same test as for SC (E)	Same frequency as SC (E)

PPA MEMORANDUM CIRCULAR
No. 02
Series of 2016
Attachment
Page 4 of 10

Materials/Items of Work	Required Tests	Minimum Incremental Frequency of Tests
Rocks	Test for Apparent Specific Gravity and Abrasion	For every 1,500 cubic meter or fraction thereof
Geotextile Filter	Physical and Mechanical Test Mill Certificate	One per batch One per batch
Sand and Gravel Fill	Quality Test for Organic Impurities and Grading	For every 1,500 cubic meter or fraction thereof
Selected Fill	Quality Test for Grading, Plasticity and Laboratory Compaction Test Laboratory California Bearing Ratio (CBR) Field Density Test	For every 1,500 cubic meter or fraction thereof For every 2,500 cubic meter or fraction thereof For every layer of 150mm of compacted depth at least one group of three In-situ density test for every 500 sq m or fraction thereof
Aggregate Base Course	Quality Test for Grading and Plasticity Quality Test for Grading, Plasticity, Abrasion and Laboratory Compaction Test Laboratory California Bearing Ratio (CBR) Field Density Test	For every 300 cubic meter or fraction thereof For every 1,500 cubic meter or fraction thereof Same frequency as Selected Fill Same frequency as Selected Fill
Portland Cement Concrete Pavement (PCCP)		
A Portland Cement	Same test as for SC (A)	Same frequency as SC (A)
B Fine Aggregate	Same test as for SC (B)	Same frequency as SC (B)
C Coarse Aggregate	Same test as for SC (C)	Same frequency as SC (C)
D Water	Same test as for SC (D)	Same frequency as SC (D)
E Steel Bars (Dowels)	Same test as for SC (E)	Same frequency as SC (E)
F Joint Filler	Quality Test	One (1) per shipment

PPA MEMORANDUM CIRCULAR
No. 02
Series of 2016
Attachment

Page 5 of 10

Materials/Items of Work	Required Tests	Minimum Incremental Frequency of Tests
G Admixture and Concrete Curing Material	Same test as for SC (G)	Same frequency as SC (G)
H Concrete	Same test as for SC (F) Flexural Test	Same frequency as SC (F) 3 beam samples for every 330 sq m or fraction thereof
I Completed Pavement	Core Test	1 set (3 specimen) for every 2,500 sq m and fraction thereof
Interlocking Concrete Blocks		
A Cement	Same test as for SC (A)	Same frequency as SC (A)
B Fine Aggregate	Same test as for SC (B)	Same frequency as SC (B)
C Coarse Aggregate	Same test as for SC (C)	Same frequency as SC (C)
D Water	Same test as for SC (D)	Same frequency as SC (D)
E Admixture & Concrete Curing Materials	Same test as for SC (G)	Same frequency as SC (G)
F Completed Blocks	Physical Test and Compressive Strength	6 blocks per day of fabrication
Cement Treated Base Course (CTB)		
A Portland Cement	Same test as for SC (A)	Same frequency as SC (A)
B Fine & Coarse Aggregates	Quality Test for Grading, Abrasion and Soundness	For every 1,500 cubic meter or fraction thereof
C Water	Same test as for SC (D)	Same frequency as SC (D)
D Completed CTB	Field Density Test	For every layer of 150mm of compacted depth at least one group of three in-situ density test every 500 sq m or fraction thereof
Retaining Wall/Coping Wall/RC Curb/RC Ditch/Shear Key/Concrete Blocks/Learn Concrete		
A Portland Cement	Same test as for SC (A)	Same frequency as SC (A)
B Fine Aggregate	Same test as for SC (B)	Same frequency as SC (B)

PPA MEMORANDUM CIRCULAR
No. 02
Series of 2016
Attachment

Page 6 of 10

Materials/Items of Work	Required Tests	Minimum Incremental Frequency of Tests
C Coarse Aggregates	Same test as for SC (C)	Same frequency as SC (C)
D Water	Same test as for SC (D)	Same frequency as SC (D)
E Steel Bars	Same test as for SC (E)	Same frequency as SC (E)
F Admixture and Concrete Curing	Same test as for SC (G)	Same frequency as SC (G)
G Concrete	Same test as for SC (F)	Same frequency as SC (F)
Tie Rod		
A Steel	Same test as for SC (E)	One per batch
B Assembly	Performance Test (Tension)	One per batch
Tie Bars and Dowels	Same test as for SC (E)	For every 10,000 kg or fraction thereof per Tie bars and Dowels
Pipe Culverts and Storm Drains		
A Pipes	Test for Strength, Absorption and Physical	For every 50 pieces
B Mortar or Joint	Same Test as for SC (A,B and D) Alternative Test Same test as for SC (F) and Inspection Report	For every 25 pieces
Concrete Hollow Blocks		
A Portland Cement	Same test as for SC (A)	Same frequency as SC (A)
B Fine Aggregates	Same test as for SC (B)	Same frequency as SC (B)
C Water	Same test as for SC (D)	Same frequency as SC (C)
D Concrete	Same test as for SC (F)	Same frequency as SC (F)
E Completed CHB	Quality Test	One for every 500 pieces or fraction thereof
Construction Joints (CJ)		
A Angle Bars	Test for Physical and Mechanical Properties	One per batch
B Steel Bars	Same test as for SC (E)	One per batch
C Zinc (Hot Dip Galvanizing) Coatings	Physical Test for Appearance, Stripping, Weighing, Adherence and Adhesion Coating Thickness Magnetic Thickness Measurement	All units 1 set (3 specimen) for every 100,000 sq mm or fraction thereof

PPA MEMORANDUM CIRCULAR
No. 02
Series of 2018
Attachment

Page 7 of 10

Materials/Items of Work	Required Tests	Minimum Incremental Frequency of Tests
Sacked Concrete		
A Cement	Same test as for SC (A)	Same frequency as SC (A)
B Fine Aggregates	Same test as for SC (B)	Same frequency as SC (B)
C Coarse Aggregates	Same test as for SC (C)	Same frequency as SC (C)
D Water	Same test as for SC (D)	Same frequency as SC (D)
E Concrete	Same test as for SC (F)	Same frequency as SC (F)
F Sack (jute)	Physical Test	One for every 50 pieces
Rubble Concrete		
A Cement	Same test as for SC (A)	Same frequency as SC (A)
B Fine Aggregates	Same test as for SC (B)	Same frequency as SC (B)
C Coarse Aggregates	Same test as for SC (C)	Same frequency as SC (C)
D Water	Same test as for SC (D)	Same frequency as SC (D)
E Concrete	Same test as for SC (F)	Same frequency as SC (F)
F Rocks	Same test as for ROCKS	Same frequency as ROCKS
Earthworks		
A Sub-grade preparation	Grading Test Plasticity Test (LL, PL, PI) Laboratory Compaction Test Density Test	For every 1,500 cubic meter or fraction thereof For every layer of 150mm of compacted depth at least one group of three in-situ density test every 500 sq m or fraction thereof
B Structure Excavation	If excavated materials shall be used as Backfill Grading Test Plasticity Test (LL, PL, PI) Laboratory Compaction Test Density Test	For every 1,500 cubic meter or fraction thereof For every layer of 150mm of compacted depth at least one group of three in-situ density test every 500 sq m or fraction thereof

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PPA MEMORANDUM CIRCULAR
No. 02
Series of 2016
Attachment
Page 8 of 10

Materials/Items of Work	Required Tests	Minimum Incremental Frequency of Tests
III Port Operations Building/Passenger Terminal Building/Transit Shed/Warehouse		
STRUCTURAL WORKS		
Refer to Structural Concrete (SC) and Piling Works (P)		
ARCHITECTURAL WORKS		
Ceramic – Filled Liquid Membrane / Water Proofing, Hydrophobic Poreblocking Ingredients with Superplasticizer	Physical Property, Mechanical and Chemical Property, Leak Test / Flood Test	One per shipment
Paint	Quality Test	One 4-L can for every 100 cans or fraction thereof
Ceramic Tile	Inspection and Evaluation Report from the Engineer	One per shipment
Stainless Steel	Inspection and Evaluation Report from the Engineer	One per shipment
Roofing Materials	Inspection and Evaluation Report from the Engineer	One per shipment
Ceiling Materials	Inspection and Evaluation Report from the Engineer	One per shipment
ELECTRICAL AND MECHANICAL WORKS		
Wires / Cables	Inspection and Evaluation Report from the Engineer Testing and Commissioning	One per shipment
Electrical Devices	Inspection and Evaluation Report from the Engineer Testing and Commissioning	One per shipment
Fire Alarm System	Inspection and Evaluation Report from the Engineer Testing and Commissioning	One per item
Wiring Devices	Inspection and Evaluation Report from the Engineer Testing and Commissioning	One per shipment

PPA MEMORANDUM CIRCULAR
No. 02
Series of 2018
Attachment

Page 8 of 10

Materials/Items of Work	Required Tests	Minimum Incremental Frequency of Tests
Protective Devices	Inspection and Evaluation Report from the Engineer Testing and Commissioning	One per shipment
Telephone System	Inspection and Evaluation Report from the Engineer Testing and Commissioning	One per item
CCTV System	Inspection and Evaluation Report from the Engineer Testing and Commissioning	One per item
CATV System	Inspection and Evaluation Report from the Engineer Testing and Commissioning	One per item
Background Music and Paging System	Inspection and Evaluation Report from the Engineer, Testing and Commissioning	One per item
Air Conditioning Units & Ventilation	Inspection and Evaluation Report from the Engineer Testing and Commissioning	One per item
Conduit Pipes	Inspection and Evaluation Report from the Engineer Testing and Commissioning	One per item
Lighting Fixtures	Inspection and Evaluation Report from the Engineer Testing and Commissioning	One per item
PLUMBING WORKS		
Pipes	Inspection and Evaluation Report from the Engineer Testing and Commissioning	One per item


PPA MEMORANDUM CIRCULAR
No. 02
Series of 2016
Attachment


Page 10 of 10

Materials/Items of Work	Required Tests	Minimum Incremental Frequency of Tests
Fixtures	Inspection and Evaluation Report from the Engineer Testing and Commissioning	One per item
Pipe Culverts	Compression Strength Inspection and Evaluation Report from the Engineer	For every size not more than 25 pipes cast in the field
IV Miscellaneous Materials Fencing A Barbed Wire, Cyclone Wire Mesh, Chain Link B Concrete Post	Physical Test (Dimensions and Coatings) Refer to Superstructure (SC)	One per Batch Refer to Superstructure (SC)
Lamp Post A Structural Steel B Zinc (Hot Dip Galvanizing) Coatings	Physical Test (Dimensions) Same test as for SC (E) Same test as for CJ (C)	All units One per batch
Drainage Steel Grating	Same test as for SC (E) Inspection Report	One (1) batch
Metal Pipe (Cast Iron Galvanized, etc)	Physical Test (Dimensions and Coatings)	1 per delivery
Welding Works	Destructive and Non Destructive Test	One (1) per lot

- NOTES**
1. Testing of RDF shall be performed only by an independent Testing Laboratory duly accredited by BRS, DOST and PPA
 2. Testing of other materials shall be performed only by an independent Testing Laboratory duly accredited by BRS and PPA.
 3. All other issuances which are otherwise inconsistent herewith are hereby revoked or otherwise amended.

Approved

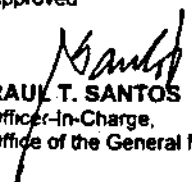
RAUL T. SANTOS
Officer-In-Charge,
Office of the General Manager

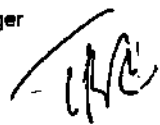

SECTION IX

CHECKLIST OF TECHNICAL AND FINANCIAL DOCUMENTS

Checklist of Technical and Financial Documents

I. TECHNICAL COMPONENT ENVELOPE

Class "A" Documents

Legal Documents

- ☐ (a) Valid PhilGEPS Registration Certificate (Platinum Membership) (all pages)

Technical Documents

- ☐ (b) Statement of the prospective bidder of all its ongoing government and private contracts, including contracts awarded but not yet started, if any, whether similar or not similar in nature and complexity to the contract to be bid; and
- ☐ (c) Statement of the bidder's Single Largest Completed Contract (SLCC) similar to the contract to be bid, except under conditions provided under the rules; and
- ☐ (d) Special PCAB License in case of Joint Ventures; and registration for the type and cost of the contract to be bid; and
- ☐ (e) Original copy of Bid Security. If in the form of a Surety Bond, submit also a certification issued by the Insurance Commission;
or
Original copy of Notarized Bid Securing Declaration; and
- ☐ (f) Project Requirements, which shall include the following:
 - ☐ a. Organizational chart for the contract to be bid;
 - ☐ b. List of contractor's key personnel (e.g., Project Manager, Project Engineers, Materials Engineers, and Foremen), to be assigned to the contract to be bid, with their complete qualification and experience data;
 - ☐ c. List of contractor's major equipment units, which are owned, leased, and/or under purchase agreements, supported by proof of ownership or certification of availability of equipment from the equipment lessor/vendor for the duration of the project, as the case may be; and
- ☐ (g) Original duly signed Omnibus Sworn Statement (OSS); and if applicable, Original Notarized Secretary's Certificate in case of a corporation, partnership, or cooperative; or Original Special Power of Attorney of all members of the joint venture giving full power and authority to its officer to sign the OSS and do acts to represent the Bidder.

Financial Documents

- ☐ (h) The prospective bidder's computation of Net Financial Contracting Capacity (NFCC).

Class "B" Documents

- ☐ (i) If applicable, duly signed joint venture agreement (JVA) in accordance with RA No. 4566 and its IRR in case the joint venture is already in existence;
or
duly notarized statements from all the potential joint venture partners stating that they will enter into and abide by the provisions of the JVA in the instance that the bid is successful.

II. FINANCIAL COMPONENT ENVELOPE

- ☐ (j) Original of duly signed and accomplished Financial Bid Form; and

Other documentary requirements under RA No. 9184

- ☐ (k) Original of duly signed Bid Prices in the Bill of Quantities; and
- ☐ (l) Duly accomplished Detailed Estimates Form, including a summary sheet indicating the unit prices of construction materials, labor rates, and equipment rentals used in coming up with the Bid; and
- ☐ (m) Cash Flow by Quarter.

SECTION X
BIDDING FORM

Bid Form for the Procurement of Infrastructure Projects

[shall be submitted with the Bid]

BID FORM

Date : _____
Project Identification No. : _____

To: Philippine Ports Authority
PPA Building, Bonifacio Drive,
South Harbor, Port Area, Manila

Having examined the Philippine Bidding Documents (PBDs) including the Supplemental or Bid Bulletin Numbers _____, the receipt of which is hereby duly acknowledged, we, the undersigned, declare that:

- a. We have no reservation to the PBDs, including the Supplemental or Bid Bulletins, for the Procurement Project: **Provision of Lay-By for Weigh-Bridge, Port of Lucena, Lucena City;**
- b. We offer to execute the Works for this Contract in accordance with the PBDs;
- c. The total price of our Bid in words and figures, excluding any discounts offered below is: _____;
- d. The discounts offered and the methodology for their application are: _____;
- e. The total bid price includes the cost of all taxes, such as, but not limited to: *[specify the applicable taxes, e.g. (i) value added tax (VAT), (ii) income tax, (iii) local taxes, and (iv) other fiscal levies and duties]*, which are itemized herein and reflected in the detailed estimates,
- f. Our Bid shall be valid within the period stated in the PBDs, and it shall remain binding upon us at any time before the expiration of that period;
- g. If our Bid is accepted, we commit to obtain a Performance Security in the amount of _____ percent of the Contract Price for the due performance of the Contract, or a Performance Securing Declaration in lieu of the the allowable forms of Performance Security, subject to the terms and conditions of issued GPPB guidelines¹ for this purpose;
- h. We are not participating, as Bidders, in more than one Bid in this bidding process, other than alternative offers in accordance with the Bidding Documents;

¹ currently based on GPPB Resolution No. 09-2020

- i. We understand that this Bid, together with your written acceptance thereof included in your notification of award, shall constitute a binding contract between us, until a formal Contract is prepared and executed; and
- j. We understand that you are not bound to accept the Lowest Calculated Bid or any other Bid that you may receive.
- k. We likewise certify/confirm that the undersigned, is the duly authorized representative of the bidder, and granted full power and authority to do, execute and perform any and all acts necessary to participate, submit the bid, and to sign and execute the ensuing contract for the **Provision of Lay-By for Weigh-Bridge, Port of Lucena, Lucena City of the Philippine Ports Authority.**
- l. We acknowledge that failure to sign each and every page of this Bid Form, including the Bill of Quantities, shall be a ground for the rejection of our bid.

Name: _____

Legal Capacity: _____

Signature: _____

Duly authorized to sign the Bid for and behalf of: _____

Date: _____

STATEMENT OF THE BIDDER'S ALL ONGOING GOVERNMENT AND PRIVATE CONTRACTS, INCLUDING CONTRACTS AWARDED BUT NOT YET STARTED

I hereby declare that all ongoing contracts, including awarded contracts yet to be started coinciding with the contract to be bid are listed below:

Name of outstanding Contracts 1]	Owner's Name and Address	Scope of Work 2]	Contractor's Role and Percentage of Participation 3]	Total Contract Amount or Value 4]	Date of Contract and NOA 5]	Value of Outstanding Works 6]	Accomplishment (in percentage, %) 7]		Contract Duration 8]	
							Planned	Actual	Start of Project	Estimated Completion Date
A) Government Contracts i. On-going ii. Awarded but not yet started										
B) Private Contracts i. On-going ii. Awarded but not yet started										

NOTE:

- 1] As appearing in the contract executed by the parties.
- 2] With special reference to the Scope of Works of the Project as described/enumerated in the Contract.
- 3] Indicate the percentage of participation and whether as Sole Contractor, Sub-Contractor or Member in a Joint Venture / Consortium.
- 4] Indicate the FOREX used if Contract Value is expressed in a currency other than the Philippine Peso.
- 5] As appearing in the Contract and Notice of Award (NOA).
- 6] Amount or value of all outstanding or uncompleted portions of the projects under ongoing contracts, including awarded contracts yet to be started coinciding with the contract to be bid.
- 7] Percentage of Accomplishment as of the preceding month which should not be earlier than two (2) months from the date of bid submission.
- 8] As appearing in the Notice to Proceed and Contract.

This Statement shall be supported by:

- a) Notice of Award
- b) Notice to Proceed and Contract

Name of Firm

Name of Bidder/Authorized Representative
(Signatory's Legal Capacity)

Date

Revised: September 2021

STATEMENT OF THE BIDDER'S SINGLE LARGEST COMPLETED CONTRACT (SLCC) SIMILAR TO THE CONTRACT TO BE BID

Name of the completed Contract 1]	Owner's Name and Address	Scope of Work 2]	Contractor's Role and Percentage of Participation 3]	Total Contract Value At 4]			Date of Award 5]	Contract Duration 6]	
				Award	Completion	Escalated Value to Present Prices		Start	Completed

NOTE :

- 1] As appearing in the contract executed by the parties.
 - 2] With special reference to the Scope of Works of the Project as described/enumerated in the Contract.
 - 3] Indicate the percentage of participation and whether as Sole Contractor, Sub-Contractor or Member in a Joint Venture / Consortium.
 - 4] Indicate the FOREX used if Contract Value is expressed in a currency other than the Philippine Peso. Attached the computation for the escalated contract value.
 - 5] As appearing in the Notice of Award.
 - 6] As appearing in the Notice to proceed and Certificate of Completion.
- A. The bidder must have an experience of having completed a SLCC that is similar to the contract to be bid equivalent to at least fifty percent (50%) of the ABC, adjusted if necessary, by the Bidder to current prices using the PSA consumer price indices. A contract is considered to be "similar" to the contract to be bid if it has the same Major Categories of Work as stated in the Bid Data Sheet (BDS).
- B. This Statement shall be supported by:
- a. Notice of Award, Notice to Proceed and Contract.
 - b. Project Owner's Certificate of Final Acceptance issued by the owner and/ or Constructors Performance Evaluation System (CPES) Final Rating, which must be at least Satisfactory. The said Certificate of Acceptance shall contain the following: 1) Name of project owner that issued the certificate, 2) Name of Contractor/ Constructor, 3) Name of Contract, and 4) Contract Duration.
 - c. Recapitulation or Final Bill of Quantities.

Name of Firm_____
Name of Bidder/Authorized Representative
(Signatory's Legal Capacity)_____
Date

Revised: September 2021

**STATEMENT OF THE BIDDER'S EXPERIENCE ON MAJOR CATEGORIES OF WORK OF THE SLCC INCLUDING OTHER COMPLETED CONTRACTS
SIMILAR TO THE CONTRACT TO BE BID**

Major Categories of Work 1]	Unit of Measure 1]	Quantity 1]	SLCC similar to the contract to be bid 2]	Other completed contracts similar to the contract to be bid 2]				Unit of Measure 2]	Quantity 2]
			Name of the contract	Name of the contract	Name of the contract	Name of the contract			
1. Portland Cement Concrete Pavement, PCCP (300mm thk.)	sq.m.	262							
2. Reinforced Concrete	cu.m.	29							

NOTE:

1] As stated in the Bid Data Sheet.

2] As appearing in the Recapitulation and/ or Final Bill of Quantities.

This statement shall be supported by:

- a. Notice of Award, Notice to Proceed and Contract.
- b. Project Owner's Certificate of Final Acceptance issued by the owner and/ or Constructors Performance Evaluation System (CPES) Final Rating, of at least satisfactory. The said Certificate of Acceptance shall contain the following: 1) Name of project owner that issued the certificate, 2) Name of Contractor/Constructor, 3) Name of Contract, and 4) Contract Duration.
- c. Recapitulation and/ or Final Bill of Quantities.

Name of Firm

Name of Bidder/Authorized Representative
Signatory's Legal Capacity

Date

Revised: September 2021

FINANCIAL DATA

- A. The prospective bidder's audited Financial Statements, showing, among others, the prospective bidder's total and current assets and liabilities, stamped "RECEIVED" by the Bureau of Internal Revenue (BIR), or its duly accredited and authorized institutions, for the preceding calendar year which should not be earlier than two (2) years from the date of bid submission.

	Year
1. Total Assets	
2. Current Assets	
3. Total Liabilities	
4. Current Liabilities	
5. Net worth (1-3)	
6. Net Working Capital (2-4)	

- B. The computation of the bidders Net Financial Contracting Capacity (NFCC) must be at least equal to the ABC to be bid, as follows:

NFCC = [(Current assets minus current liabilities) (15)] minus the value of all outstanding or uncompleted portions of the projects under ongoing contracts, including awarded contracts yet to be started coinciding with the contract to be bid.

NFCC = _____

Attached herewith are certified true copies of the audited financial statements stamped received by the BIR or BIR authorized collecting agent for the latest/immediately preceding calendar year.

Name of Firm/Applicant

Authorized Signing Official

Date: _____

NOTES:

If Partnership or Joint Venture, each Partner or Member Firm of Joint venture shall submit separate financial statements.

STATEMENT OF THE BIDDER'S KEY PERSONNEL PLEDGED FOR THE CONTRACT TO BE BID

I hereby declare that the following key personnel are qualified and available for the duration of the contract to be bid:

Position of Key Personnel 1]	Name	No. of Key Personnel	Similar Experience in the Position (Years) 2]	Total Experience in the Position (Years)	Attachment(s)	Annex(es)
Project Engineer					PRC License (CE Preferred) Complete Qualification and Experience Data Certificate of Commitment	Annex " _ "
Materials Engineer I					PRC License (CE Preferred) Submit Valid and Renewed DPWH Certificate of Accreditation Submit Accreditation Identification Card as Materials Engineer Complete Qualification and Experience Data Certificate of Commitment	Annex " _ "
Construction Safety and Health Officer					Certificate of Safety and Health Construction Related Course issued by DOLE Accredited Trainings Complete Qualification and Experience Data Certificate of Commitment	Annex " _ "
Foreman					Complete Qualification and Experience Data Certificate of Commitment	Annex " _ "
Other Position(s)					Complete Qualification and Experience Data Certificate of Commitment	Annex " _ "

NOTE: 1] As stated in the Bid Data Sheet

2] The number of years of experience of the key personnel shall be as indicated in the qualification and experience data or curriculum vitae.

Minimum qualification requirements: The key personnel must have a work experience that is similar in nature and complexity to the contract to be bid.

Project Manager - Five (5) years

Materials Engineer – One (1) year

Project Engineer - Three (3) years

Materials Engineer I – for projects costing up to 100M

Foreman - Five (5) years

Materials Engineer II – for projects costing more than 100M

Construction Safety and Health Officer – One (1) year

Name of Firm

Name of Bidder/Authorized Representative
(Signatory's Legal Capacity)

Date

Revised: September 2021

STATEMENT OF THE BIDDER'S EQUIPMENT PLEDGED FOR THE CONTRACT TO BE BID

I hereby declare that the following equipment are in good operating condition and available for the duration of the contract to be bid:

DESCRIPTION (Type, Model, Make)	No. of Unit(s)	Capacity/ Output 1]	Owned, Leased, and/or under purchased agreement 2]	Proof of Ownership/ Leased/ Under Purchase Agreement (Mark as Annex "A.....Z") 3]	OTHER INFORMATION (As Applicable)				
					Manufacturer	Engine Serial No.	Chassis No./ Name of Vessel	Location	Status

NOTE:

- 1] The unit of capacity of the pledged equipment shall be as indicated in the Proof of Ownership, i.e. GW (for crane barge), DWT (for deck barge and hopper barge), Ton (for crane, road roller and drop hammer), kg.-m/blow (for diesel hammer), cu.m. (for dump truck), hp (for tugboat, road grader, bulldozer and concrete vibrator), cfm (for compressor), gal (for water truck with pump), amp (for welding machine), bagger (for concrete mixer). If the capacity of the pledged equipment is not indicated in the Proof of Ownership/Leased Contract/Purchased Agreement, submit other proof of capacity such as specifications, brochures or other verifiable printouts indicating the model name, model number and other details of the equipment.
- 2] Indicate if the pledged equipment are owned, leased or under purchase agreement.
- 3] If the pledged equipment is owned, it should be in the name of the bidder. Submit proof of ownership, i.e. deed of sale, sales invoice, official receipt; For owned Water Truck, Dump Truck and Transit Mixer submit LTO Certificate of Registration and valid Official Receipt; For owned barge/tugboat, submit Marina Certificate of Ownership and valid Cargo Ship Safety Certificate.

If the pledged equipment is leased/under purchased agreement, submit certification of availability of equipment from the equipment lessor/vendor for the duration of the project, and duly Notarized copy of leased contract/purchased agreement.

If the pledged barge/tugboat is leased/under purchase agreement, submit certification of availability of barge/tugboat from the equipment lessor/vendor for the duration of the project, and duly Notarized copy of leased contract/purchased agreement together with a copy of the Marina Certificate of Ownership and valid Cargo Ship Safety Certificate.

The Minimum Major Equipment Requirements are listed in Section 8, Annex 3.

Name of Firm

Name of Bidder/Authorized Representative
(Signatory's Legal Capacity)

Date

Revised: September 2021

Omnibus Sworn Statement for Sole Proprietorship
[shall be submitted with the Bid]

REPUBLIC OF THE PHILIPPINES)
CITY/MUNICIPALITY OF _____) S.S.

AFFIDAVIT

I, _____, of legal age, [Civil Status], [Nationality], and residing at _____, after having been duly sworn in accordance with law, do hereby depose and state that:

1. I am the sole proprietor or authorized representative of _____ with office address at _____;
2. As the owner and sole proprietor, or authorized representative of _____, I have full power and authority to do, execute and perform any and all acts necessary to participate, submit the bid, and to sign and execute the ensuing contract for **Provision of Lay-By Area for Weigh Bridge, Port of Lucena, Lucena City of the Philippine Ports Authority**, as shown in the attached duly notarized Special Power of Attorney;
3. [Name of Bidder] is not "blacklisted" or barred from bidding by the Government of the Philippines or any of its agencies, offices, corporations, or Local Government Units, foreign government/foreign or international financing institution whose blacklisting rules have been recognized by the Government Procurement Policy Board, by itself or by relation, membership, association, affiliation, or controlling interest with another blacklisted person or entity as defined and provided for in the Uniform Guidelines on Blacklisting;
4. Each of the documents submitted in satisfaction of the bidding requirements is an authentic copy of the original, complete, and all statements and information provided therein are true and correct;
5. [Name of Bidder] is authorizing the Head of the Procuring Entity or its duly authorized representative(s) to verify all the documents submitted;
6. The owner or sole proprietor is not related to the Head of the Procuring Entity, Procuring Agent if engaged, members of the Bids and Awards Committee (BAC), the Technical Working Group, and the BAC Secretariat, the head of the Project Management Office or the end-user unit, and the project consultants by consanguinity or affinity up to the third civil degree;
7. [Name of Bidder] complies with existing labor laws and standards; and
8. [Name of Bidder] is aware of and has undertaken the responsibilities as a Bidder in compliance with the Philippine Bidding Documents, which includes:
 - a. Carefully examining all of the Bidding Documents;
 - b. Acknowledging all conditions, local or otherwise, affecting the implementation of the Contract;
 - c. Making an estimate of the facilities available and needed for the contract to be bid, if any; and
 - d. Inquiring or securing Supplemental/Bid Bulletin(s) issued for the [Name of the Project].

9. *[Name of Bidder]* did not give or pay directly or indirectly, any commission, amount, fee, or any form of consideration, pecuniary or otherwise, to any person or official, personnel or representative of the government in relation to any procurement project or activity.
10. In case advance payment was made or given, failure to perform or deliver any of the obligations and undertakings in the contract shall be sufficient grounds to constitute criminal liability for Swindling (Estafa) or the commission of fraud with unfaithfulness or abuse of confidence through misappropriating or converting any payment received by a person or entity under an obligation involving the duty to deliver certain goods or services, to the prejudice of the public and the government of the Philippines pursuant to Article 315 of Act No. 3815 s. 1930, as amended, or the Revised Penal Code.

IN WITNESS WHEREOF, I have hereunto set my hand this __ day of __, 20__ at _____, Philippines.

Name of Bidder/ Authorized Representative
(Signatory's Legal Capacity)
AFFIANT

[Jurat]
[Format shall be based on the latest Rules on Notarial Practice]

Omnibus Sworn Statement for Partnership or Cooperative
[shall be submitted with the Bid]

REPUBLIC OF THE PHILIPPINES)
CITY/MUNICIPALITY OF _____) S.S.

AFFIDAVIT

I, _____, of legal age, [Civil Status], [Nationality], and residing at _____,
after having been duly sworn in accordance with law, do hereby depose and state that:

1. I am the duly authorized and designated representative of _____ with office address at _____;
2. I am granted full power and authority to do, execute and perform any and all acts necessary to participate, submit the bid, and to sign and execute the ensuing contract for **Provision of Lay-By Area for Weigh Bridge, Port of Lucena, Lucena City of the Philippine Ports Authority**, as shown in the attached [state title of attached document showing proof of authorization (e.g., duly notarized Secretary's Certificate, Board/Partnership Resolution, or Special Power of Attorney, whichever is applicable;)];
3. [Name of Bidder] is not "blacklisted" or barred from bidding by the Government of the Philippines or any of its agencies, offices, corporations, or Local Government Units, foreign government/foreign or international financing institution whose blacklisting rules have been recognized by the Government Procurement Policy Board, by itself or by relation, membership, association, affiliation, or controlling interest with another blacklisted person or entity as defined and provided for in the Uniform Guidelines on Blacklisting;
4. Each of the documents submitted in satisfaction of the bidding requirements is an authentic copy of the original, complete, and all statements and information provided therein are true and correct;
5. [Name of Bidder] is authorizing the Head of the Procuring Entity or its duly authorized representative(s) to verify all the documents submitted;
6. None of the officers and members of [Name of Bidder] is related to the Head of the Procuring Entity, Procuring Agent if engaged, members of the Bids and Awards Committee (BAC), the Technical Working Group, and the BAC Secretariat, the head of the Project Management Office or the end-user unit, and the project consultants by consanguinity or affinity up to the third civil degree;
7. [Name of Bidder] complies with existing labor laws and standards; and
8. [Name of Bidder] is aware of and has undertaken the responsibilities as a Bidder in compliance with the Philippine Bidding Documents, which includes:
 - a. Carefully examining all of the Bidding Documents;
 - b. Acknowledging all conditions, local or otherwise, affecting the implementation of the Contract;
 - c. Making an estimate of the facilities available and needed for the contract to be bid, if any; and
 - d. Inquiring or securing Supplemental/Bid Bulletin(s) issued for the [Name of the Project].

9. [Name of Bidder] did not give or pay directly or indirectly, any commission, amount, fee, or any form of consideration, pecuniary or otherwise, to any person or official, personnel or representative of the government in relation to any procurement project or activity.
10. In case advance payment was made or given, failure to perform or deliver any of the obligations and undertakings in the contract shall be sufficient grounds to constitute criminal liability for Swindling (Estafa) or the commission of fraud with unfaithfulness or abuse of confidence through misappropriating or converting any payment received by a person or entity under an obligation involving the duty to deliver certain goods or services, to the prejudice of the public and the government of the Philippines pursuant to Article 315 of Act No. 3815 s. 1930, as amended, or the Revised Penal Code.

IN WITNESS WHEREOF, I have hereunto set my hand this __ day of __, 20__ at _____, Philippines.

Name of Bidder/ Authorized Representative
(Signatory's Legal Capacity)
AFFIANT

[Jurat]

[Format shall be based on the latest Rules on Notarial Practice]

Omnibus Sworn Statement for Corporation or Joint Venture
[shall be submitted with the Bid]

REPUBLIC OF THE PHILIPPINES)
CITY/MUNICIPALITY OF _____) S.S.

AFFIDAVIT

I, _____, of legal age, [Civil Status], [Nationality], and residing at _____,
after having been duly sworn in accordance with law, do hereby depose and state that:

1. I am the duly authorized and designated representative of _____ with office address at _____;
2. I am granted full power and authority to do, execute and perform any and all acts necessary to participate, submit the bid, and to sign and execute the ensuing contract for **Provision of Lay-By Area for Weigh Bridge, Port of Lucena, Lucena City**, as shown in the attached [state title of attached document showing proof of authorization (e.g., duly notarized Secretary's Certificate, Board/Partnership Resolution, or Special Power of Attorney, whichever is applicable)];
3. [Name of Bidder] is not "blacklisted" or barred from bidding by the Government of the Philippines or any of its agencies, offices, corporations, or Local Government Units, foreign government/foreign or international financing institution whose blacklisting rules have been recognized by the Government Procurement Policy Board, by itself or by relation, membership, association, affiliation, or controlling interest with another blacklisted person or entity as defined and provided for in the Uniform Guidelines on Blacklisting;
4. Each of the documents submitted in satisfaction of the bidding requirements is an authentic copy of the original, complete, and all statements and information provided therein are true and correct;
5. [Name of Bidder] is authorizing the Head of the Procuring Entity or its duly authorized representative(s) to verify all the documents submitted;
6. None of the officers, directors, and controlling stockholders of [Name of Bidder] is related to the Head of the Procuring Entity, Procuring Agent if engaged, members of the Bids and Awards Committee (BAC), the Technical Working Group, and the BAC Secretariat, the head of the Project Management Office or the end-user unit, and the project consultants by consanguinity or affinity up to the third civil degree;
7. [Name of Bidder] complies with existing labor laws and standards; and
8. [Name of Bidder] is aware of and has undertaken the responsibilities as a Bidder in compliance with the Philippine Bidding Documents, which includes:
 - a. Carefully examining all of the Bidding Documents;
 - b. Acknowledging all conditions, local or otherwise, affecting the implementation of the Contract;
 - c. Making an estimate of the facilities available and needed for the contract to be bid, if any; and
 - d. Inquiring or securing Supplemental/Bid Bulletin(s) issued for the [Name of the Project].
9. [Name of Bidder] did not give or pay directly or indirectly, any commission, amount, fee, or any

form of consideration, pecuniary or otherwise, to any person or official, personnel or representative of the government in relation to any procurement project or activity.

10. In case advance payment was made or given, failure to perform or deliver any of the obligations and undertakings in the contract shall be sufficient grounds to constitute criminal liability for Swindling (Estafa) or the commission of fraud with unfaithfulness or abuse of confidence through misappropriating or converting any payment received by a person or entity under an obligation involving the duty to deliver certain goods or services, to the prejudice of the public and the government of the Philippines pursuant to Article 315 of Act No. 3815 s. 1930, as amended, or the Revised Penal Code.

IN WITNESS WHEREOF, I have hereunto set my hand this __ day of __, 20__ at _____, Philippines.

Name of Bidder/ Authorized Representative
(Signatory's Legal Capacity)
AFFIANT

[Jurat]

[Format shall be based on the latest Rules on Notarial Practice]

Bid Securing Declaration Form

[shall be submitted with the Bid if bidder opts to provide this form of bid security]

REPUBLIC OF THE PHILIPPINES)
CITY OF _____) S.S.

BID SECURING DECLARATION **Project Identification No.: _____**

To: **Philippine Ports Authority**
PPA Building, Bonifacio Drive,
South Harbor, Port Area, Manila

I/We, the undersigned, declare that:

1. I/We understand that, according to your conditions, bids must be supported by a Bid Security, which may be in the form of a Bid Securing Declaration.
2. I/We accept that: (a) I/we will be automatically disqualified from bidding for any procurement contract with any procuring entity for a period of two (2) years upon receipt of your Blacklisting Order; and, (b) I/we will pay the applicable fine provided under Section 6 of the Guidelines on the Use of Bid Securing Declaration, within fifteen (15) days from receipt of the written demand by the procuring entity for the commission of acts resulting to the enforcement of the bid securing declaration under Sections 23.1(b), 34.2, 40.1 and 69.1, except 69.1(f), of the IRR of RA No. 9184; without prejudice to other legal action the government may undertake.
3. I/We understand that this Bid Securing Declaration shall cease to be valid on the following circumstances:
 - a. Upon expiration of the bid validity period, or any extension thereof pursuant to your request;
 - b. I am/we are declared ineligible or post-disqualified upon receipt of your notice to such effect, and (i) I/we failed to timely file a request for reconsideration or (ii) I/we filed a waiver to avail of said right; and
 - c. I am/we are declared the bidder with the Lowest Calculated Responsive Bid, and I/we have furnished the performance security and signed the Contract.

IN WITNESS WHEREOF, I/We have hereunto set my/our hand/s this ____ day of [month] [year] at [place of execution].

Name of Bidder/ Authorized Representative
(Signatory's Legal Capacity)
AFFIANT

[Jurat]

[Format shall be based on the latest Rules on Notarial Practice]

CONSTRUCTION METHODOLOGY

Name of Project : _____
Project Description : _____
Location : _____

MINIMUM SCOPE OF CONSTRUCTION METHODOLOGY

- Demolition of existing sidewalk including disposal.
- Clearing, grubbing and scarifying of unsuitable materials including disposal
- Excavation of existing materials
- Supply, place and compact 250mm thk. selected fill materials (for correction due to uneven ground surface)
- Supply and place gravel base course
- Supply and place 4,500 psi concrete for portland cement concrete pavement, PCCP
- Supply and place 4,500 psi concrete for weigh bridge foundation, drainage, segregation island and sidewalk & gutter
- Supply and place 3,500 psi concrete for control room
- Supply and install temperature bars for item 2.05(a)
- Supply and install reinforcing steel bars for item 2.05(b) and 2.05 (c)
- Masonry works
- Supply and install doors and windows including accessories
- Electrical works
- Supply and Lay 450mm dia. reinforced concrete pipe for drainage
- Provision of landscaping materials for segregation island
- Supply and place concrete for pedestal port including steel reinforcements for solar-powered port lights
- Supply and install port lighting post with integrated solar-powered port lighting complete with fittings and accessories
- Painting works

NOTES:

The narrative construction method will guide and familiarize the contractor and the PPA on how the project shall be carried out in accordance with the highest standard of workmanship.

The construction method shall be consistent with the Bar Chart / S-Curve Schedule, Equipment Schedule and Manpower Schedule.

Name of Bidder/Authorized Representative
(Signatory's Legal Capacity)

MANPOWER SCHEDULE

Name of Project : _____

Project Description : _____

Location : _____

MANPOWER (Minimum)	CONTRACT DURATION (_____ Calendar Days)																											
	M O N T H L Y																											
	1	2	3	4	5	6	7	8	9	10	11	12	13	14	15	16	17	18	19	20	21	22	23	24	25	26	27	28
Project Manager																												
Project Engineer																												
Materials Engineer I																												
Construction Safety and Health Officer																												
Foreman																												
Specify other applicable positions, ie.:																												
- Carpenter																												
- Steelman																												
- Mason																												
- Electrician																												
- Rigger																												
- Others																												

Name of Bidder/Authorized Representative
(Signatory's Legal Capacity)

Revised: September 2021

EQUIPMENT UTILIZATION SCHEDULE

Name of Project : _____

Project Description : _____

Location : _____

[illegible]

**Name of Bidder/Authorized Representative
(Signatory's Legal Capacity)**

Revised: September 2021

CASHFLOW BY QUARTER AND PAYMENT SCHEDULE

Name of Project: : _____

Project Description : _____

Location : _____

Project Duration (days or months)	Payment Schedule (Monthly, in Pesos)	Cash flow (Quarterly, in Pesos)
TOTAL		

NOTES

- The cash flow by quarter and payment schedule should be consistent with the Bar Chart and S-curb.
- Payment schedule shall not be more than once a month.

Name of Bidder/Authorized Representative
(Signatory's Legal Capacity)

Revised: September 2021

Contract Agreement Form for the Procurement of Infrastructure Projects (Revised)

*[not required to be submitted with the Bid, but it shall be submitted within ten (10) days after
receiving the Notice of Award]*

CONTRACT AGREEMENT

THIS AGREEMENT, made this _____ day of _____, _____ between **Philippine Ports Authority** with principal office at PPA Building, Bonifacio Drive, South Harbor, Port Area, Manila (hereinafter called the "Entity") and **[name and address of Contractor]** (hereinafter called the "Contractor").

WHEREAS, the Entity is desirous that the Contractor execute **[name and identification number of contract]** (hereinafter called "the Works") and the Entity has accepted the Bid for **[contract price in words and figures in specified currency]** by the Contractor for the execution and completion of such Works and the remedying of any defects therein.

NOW THIS AGREEMENT WITNESSETH AS FOLLOWS:

1. In this Agreement, words and expressions shall have the same meanings as are respectively assigned to them in the Conditions of Contract hereinafter referred to.
2. The following documents as required by the 2016 revised Implementing Rules and Regulations of Republic Act No. 9184 shall be deemed to form and be read and construed as part of this Agreement, viz.:

- a. Philippine Bidding Documents (PBDs);
 - i. Drawings/Plans;
 - ii. Specifications;
 - iii. Bill of Quantities;
 - iv. General and Special Conditions of Contract;
 - v. Supplemental or Bid Bulletins, if any;
- b. Winning bidder's bid, including the Eligibility requirements, Technical and Financial Proposals, and all other documents or statements submitted;

Bid form, including all the documents/statements contained in the Bidder's bidding envelopes, as annexes, and all other documents submitted (e.g., Bidder's response to request for clarifications on the bid), including corrections to the bid, if any, resulting from the Procuring Entity's bid evaluation;

- c. Performance Security;
- d. Notice of Award of Contract and the Bidder's conforme thereto; and
- e. Other contract documents that may be required by existing laws and/or the Procuring Entity concerned in the PBDs. Winning bidder agrees that additional contract documents or information prescribed by the GPPB that are subsequently required for submission after the contract execution, such as the Notice to Proceed, Variation Orders, and Warranty Security, shall likewise form part of the Contract.

3. In consideration for the sum of **[total contract price in words and figures]** or such other sums as may be ascertained, **[Named of the bidder]** agrees to **[state the object of the contract]** in accordance with his/her/its Bid.
4. The **Philippine Ports Authority** agrees to pay the above-mentioned sum in accordance with the terms of the Bidding.

IN WITNESS whereof the parties thereto have caused this Agreement to be executed the day and year first before written.

JAY DANIEL R. SANTIAGO
General Manager

for:

Philippine Ports Authority

**Name of Bidder/ Authorized
Representative**
(Signatory's Legal Capacity)

for:

Contractor

Acknowledgment

[Format shall be based on the latest Rules on Notarial Practice]